# **Broad Development Parameters of the Applied Use/Development** in respect of Application No. A/SK-CWBN/75 關乎申請編號 A/SK-CWBN/75 的擬議用途/發展的概括發展規範

Application No. 申請編號	A/SK-CWBN/75							
Location/address 位置/地址	Government Land in D.D. 238, Pan Long Wan, Clear Water Bay, Sai Kung, New Territories 新界西貢清水灣檳榔灣丈量約份第 238 約的政府土地							
Site area 地盤面積	About 約 26 sq. m 平方米 (Includes Government Land of about 包括政府土地約 26 sq. m 平方米) sq. m 平方米							
Plan 圖則	Approved Clear Water Bay Peninsula North Outline Zoning Plan No. S/SK-CWBN/6 清水灣半島北分區計劃大綱核准圖編號 S/SK-CWBN/6							
Zoning 地帶	"Conservation Area" 「自然保育區」							
Applied use/ development 申請用途/發展	Proposed Public Utility Installation (Poles and Underground Cable) and Associated  Excavation of Land							
	擬議公用事業設施裝置(電線桿和地底電纜)和相關的挖土工程							
Gross floor area and/or plot ratio 總樓面面積及/ 或地積比率		sq. m 平方米	Plot ratio 地積比率					
	Domestic 住用	-	-					
	Non-domestic 非住用	-	-					
No. of block 幢數	Domestic 住用	-						
	Non-domestic 非住用	-						
	Composite 綜合用途	-						
Building height/No.	Domestic - m 米							

of storeys 建築物高度/ 層數	住用	-	mPD 米(主水平基準上)
		-	Storey(s) 層
	Non-domestic	-	m米
	非住用	-	mPD 米(主水平基準上)
		-	Storey(s) 層
	Composite 綜合用途	-	m米
		-	mPD 米(主水平基準上)
		-	Storey(s) 層
Site coverage 上蓋面積		-	
No. of units 單位數目		-	
Open space 休憩用地	Private 私人	-	sq. m平方米
	Public 公眾	-	sq. m平方米
No. of parking			
spaces and loading			
/ unloading spaces		-	
停車位及上落客貨			
車位數目			


<sup>\*</sup> 有關資料是為方便市民大眾參考而提供。對於所載資料在使用上的問題及文義上的歧異,城市規劃委員會概不負責。若有任何疑問,應查閱申請人提交的文件。


The information is provided for easy reference of the general public. Under no circumstances will the Town Planning Board accept any liabilities for the use of the information nor any inaccuracies or discrepancies of the information provided. In case of doubt, reference should always be made to the submission of the applicant.

Submitted Plans, Drawings and Documents 提交的圖則、繪圖及文件							
	<u>Chinese</u> 中文	English 英文					
Plans and Drawings 圖則及繪圖							
Master layout plan(s)/Layout plan(s) 總綱發展藍圖/布局設計圖 Block plan(s) 樓宇位置圖 Floor plan(s) 樓宇平面圖 Sectional plan(s) 截視圖 Elevation(s) 立視圖 Photomontage(s) showing the proposed development 顯示擬議發展的合成照片 Master landscape plan(s)/Landscape plan(s) 園境設計總圖/園境設計圖 Others (please specify) 其他(請註明)							
Reports 報告書 Planning Statement / Justifications 規劃綱領 / 理據 Environmental assessment (noise, air and/or water pollutions) 環境評估 (噪音、空							
氣及/或水的污染) Traffic impact assessment (on vehicles) 就車輛的交通影響評估 Traffic impact assessment (on pedestrians) 就行人的交通影響評估 Visual impact assessment 視覺影響評估 Landscape impact assessment 景觀影響評估 Tree Survey 樹木調查 Geotechnical impact assessment 土力影響評估 Drainage impact assessment 排水影響評估 Sewerage impact assessment 排水影響評估 Risk Assessment 風險評估 Others (please specify) 其他(請註明)							
Note: May insert more than one「✔」. 註:可在多於一個方格內加上「✔」號							

Note: The information in the Gist of Application above is provided by the applicant for easy reference of the general public. Under no circumstances will the Town Planning Board accept any liabilities for the use of the information nor any inaccuracies or discrepancies of the information provided. In case of doubt, reference should always be made to the submission of the applicant.

註: 上述申請摘要的資料是由申請人提供以方便市民大眾參考。對於所載資料在使用上的問題及文義上的歧異,城市規劃委員會概不負責。若有任何疑問,應查閱申請人提交的文件。

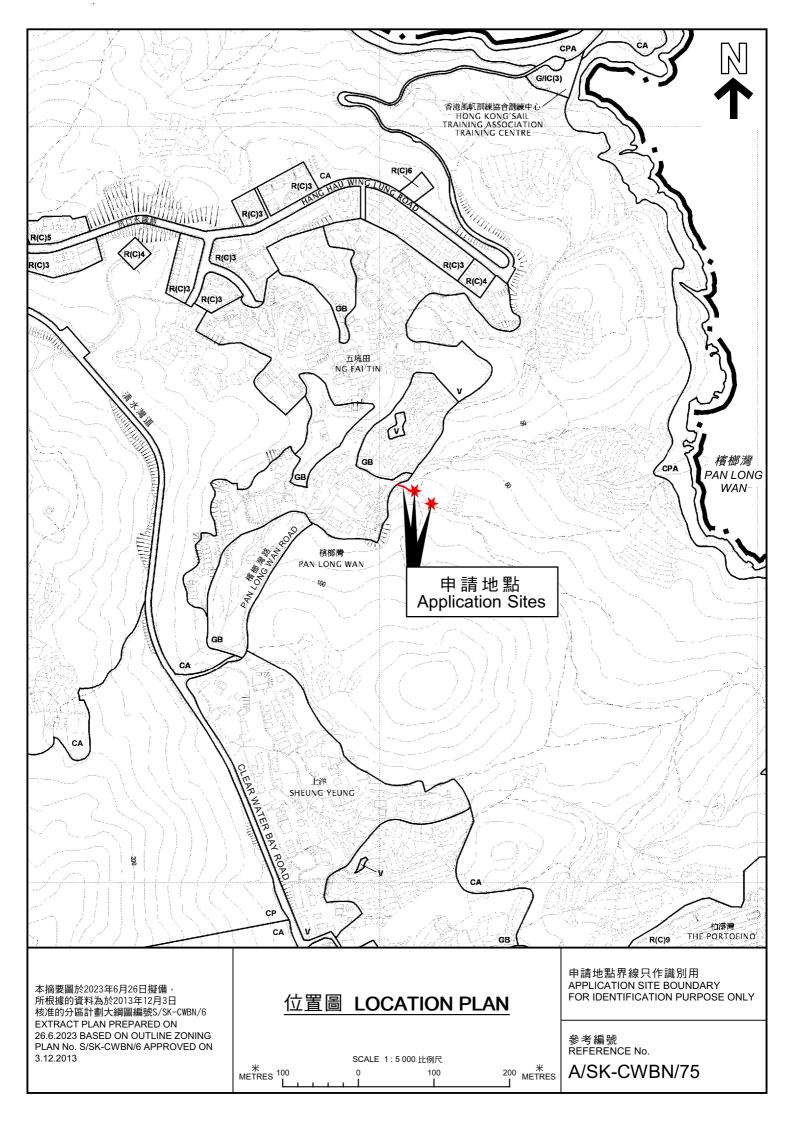

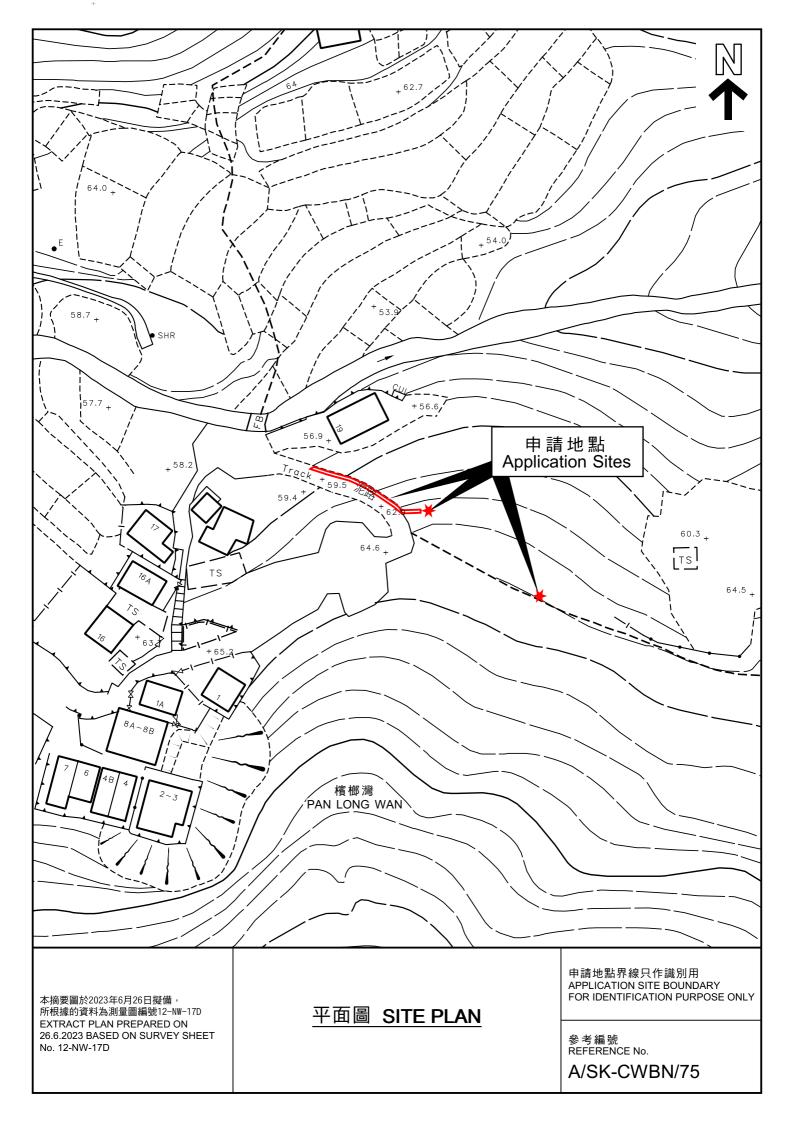

## 申請編號 Application No.: A/SK-CWBN/75


# 備註 Remarks

申請人要求批給規劃許可,准許將申請地點用作擬議公用事業設施裝置(電線桿和地底電纜)和相關的挖土工程(1.2至1.8米深)。申請地點擬議設置一條地底電纜(24米長、1米闊及1.2米深)及兩枝電線桿(各約1米長、1米闊、1.8米深及7.2米高)。

The applicant seeks planning permission to use the application sites for proposed public utility installation (poles and underground cable) and associated excavation of land (1.2 to 1.8m in depth). An underground cable  $(24m(L) \times 1m(W) \times 1.2m(D))$  and two poles (about  $1m(H) \times 1m(W) \times 1.8(D) \times 7.2m(H)$  each) are proposed within the application sites.


有關資料是為方便市民大眾參考而提供。對於所載資料在使用上的問題及文義上的歧異,城市規劃委員會概不負責。若有任何疑問,應查閱申請人提交的文件。

The information is provided for easy reference of the general public. Under no circumstances will the Town Planning Board accept any liabilities for the use of the information nor any inaccuracies or discrepancies of the information provided. In case of doubt, reference should always be made to the submission of the applicant.

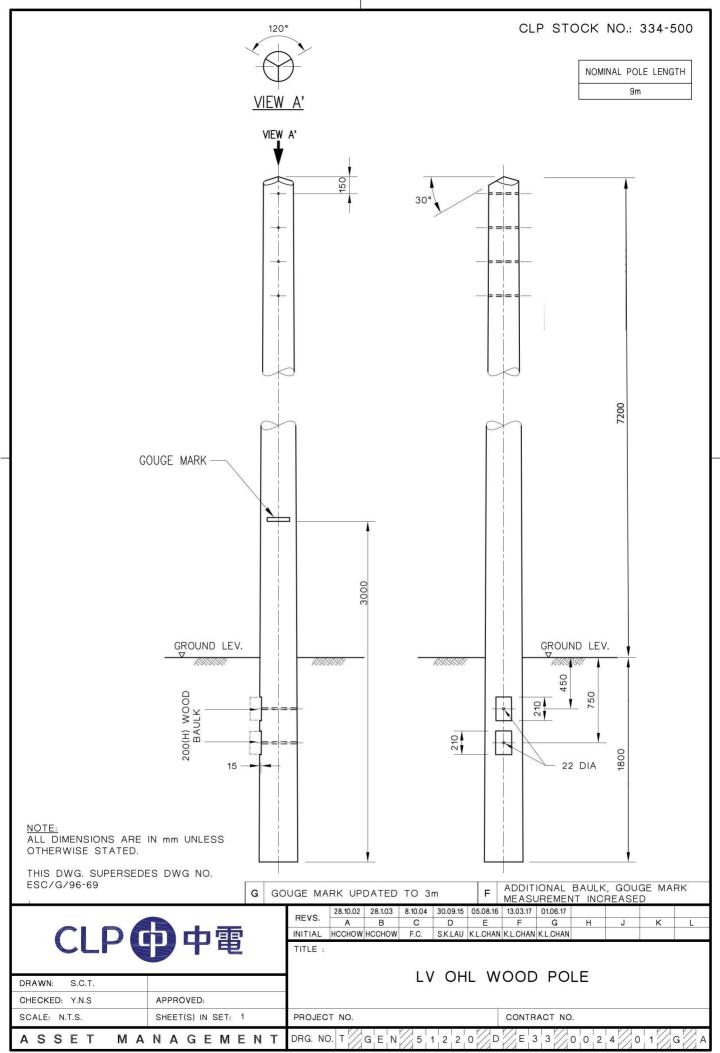

INFORMATION CLASS: PROPRIETARY

ALL RIGHTS RESERVED AND REPRODUCTION IN ANY FORM MUST BE APPROVED BY CLP POWER

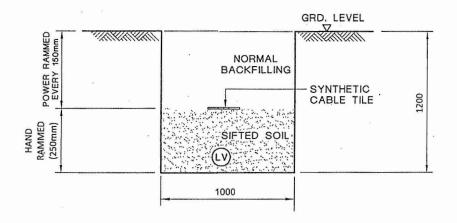

TYPICAL CABLE TRENCH FOR SINGLE LV CABLE

### LEGEND :




LV CABLE

#### NOTES:

- 1. ALL SOIL BACKFILLING BENEATH CABLE TILES SHALL BE SIFTED THROUGH 12mm WIRE MESH.
- ALL DIMENSIONS ARE IN mm.

C GENERAL REVISION	В	GENE	ENERAL REVISION					Α	SYNTHETIC CABLE TILE SPECIFIED						
			REVS.	16-2-04	18-6-07	28-6-07									
CLP (B) 中電			REVS.	Α	В	С	D	Ε	F	G	Н	J	K	L	
			INITIAL	C.Y.IP	W.B.LEE	Y.K.MAN									
			TITLE :												
					TYP	IC A	1	VIC	AR	IF	TRE	NOF	1		
DRAWN: S.C.T.		- 1			1 1 1	10/1		v C			1111	IVOI	,		
CHECKED: K. K. LEUNG APPROVED: W.	B. L	EE													
SCALE: 1: 15 SHEET(S) IN SET: 1			PROJECT NO.						CONTRACT NO.						
ASSET MANAGEME	N	Т	DRG. NO	T 🔀	G E N	2 5	5 0	0//0	E:	3 3	0 0 0	2/0	120	A	

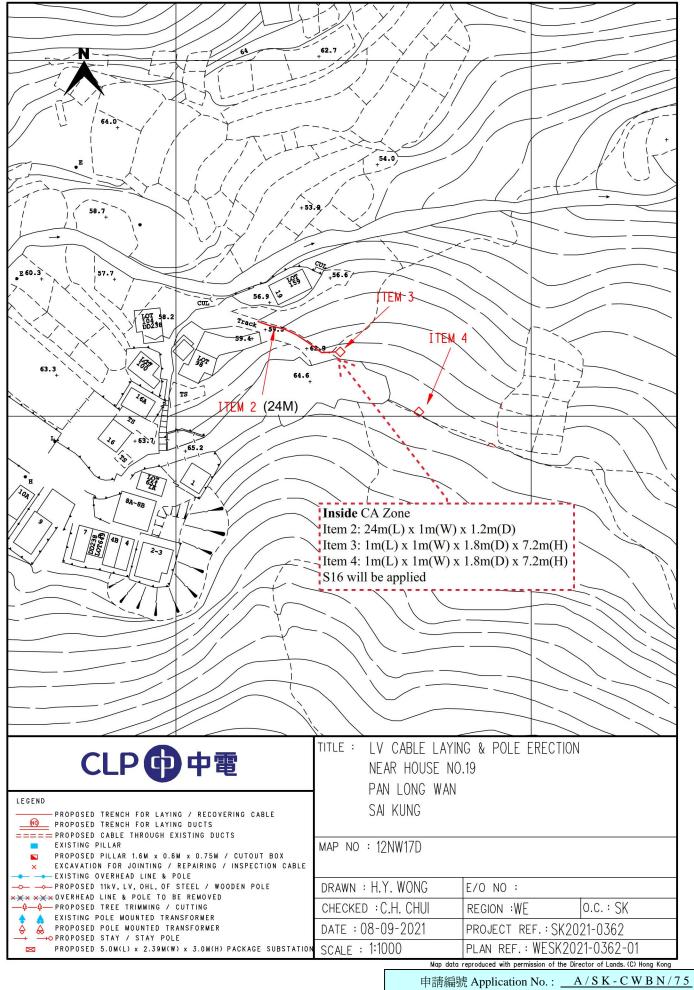

此頁摘自申請人提交的文件。