Broad Development Parameters of the Applied Use/Development in respect of Application No. A/H10/95 關乎申請編號 A/H10/95 的擬議用途/發展的概括發展規範

Application No. 申請編號	A/H10/95				
Location/address 位置/地址	Telegraph Bay, Pok Fu Lam, Hong Kong 香港薄扶林鋼綫灣				
Site area 地盤面積	地盤總面積 Gross Site Area		About 約 16,296 sq. m 平方米 (Includes Government Land of about 包括政府土地約 16,296 sq. m 平方米)		
	發展地盤面積 Development Site Area		About 約 15,869 sq. m 平方米		
Plan 圖則	Approved Pok Fu Lam Outline Zoning Plan No. S/H10/19 薄扶林分區計劃大綱核准圖編號 S/H10/19				
Zoning 地帶	"Other Specified Uses" annotated "Cyber-Port(1)" 「其他指定用途」註明「數碼港(1)」				
Applied use/ development 申請用途/發展	Proposed Permitted Office, Exhibition or Convention Hall, Information Technology and Telecommunications Industries, Eating Place, and Shop and Services Uses 擬議准許的辦公室、展覽或會議廳、資訊科技及電訊業、食肆、以及商店及服務行業用途				
Gross floor area and/or plot ratio 總樓面面積及/ 或地積比率		sq. m 平方米		Plot ratio 地積比率	
	Domestic 住用	-		-	
	Non-domestic 非住用	Not more than 不多於 66,000		About 約 4.159	
No. of block 幢數	Domestic 住用	-			
	Non-domestic 非住用	1			
	Composite 綜合用途		-		
Building height/No. of storeys 建築物高度/ 層數	Domestic 住用	-		m米	
		-		mPD 米(主水平基準上)	
		-		Storey(s) 層	
	Non-domestic 非住用	-		m米	
		58		mPD 米(主水平基準上)	
		10		Storey(s) 層 Exclude 不包括	
		2		Basement 地庫	
	Composite 綜合用途	-		m米	
		-		mPD 米(主水平基準上)	

		- Storey(s) 層		
Site coverage 上蓋面積	About 約 58 %			
No. of units 單位數目	-			
Open space 休憩用地	Private 私人	-	sq. m平方米	
	Public 公眾 (At-grade 地面)	Not less than 不少於 5,000	sq. m平方米	
No. of parking	Total no. of vehicle spaces 停車位總數		219	
spaces and loading				
/ unloading spaces	Private Car Parking Spaces (including 4 no. accessible		198	
停車位及上落客貨	parking space) 私家車車位 (包括 4 個殘疾人士專用泊			
車位數目	車位)			
	Motorcycle Parking Spaces 電單車車位 Total no. of vehicle loading/unloading bays/lay-bys 上落客貨車位/停車處總數		21	
			28	
	Taxi Spaces 的士車位		2	
	Light Goods Vehicle Spaces 輕型貨車車位		17	
	Heavy Goods Vehicle Spaces 重型貨車車位		9	


^{*} 有關資料是為方便市民大眾參考而提供。對於所載資料在使用上的問題及文義上的歧異,城市規劃委員會概不負責。若有任何疑問,應查閱申請人提交的文件。


The information is provided for easy reference of the general public. Under no circumstances will the Town Planning Board accept any liabilities for the use of the information nor any inaccuracies or discrepancies of the information provided. In case of doubt, reference should always be made to the submission of the applicant.

Submitted Plans, Drawings and Documents 提交的圖則、繪圖及文件			
	<u>Chinese</u> 中文	English 英文	
Plans and Drawings 圖則及繪圖			
Master layout plan(s)/Layout plan(s)		✓	
Block plan(s) 樓宇位置圖		_	
Floor plan(s) 樓宇平面圖		\checkmark	
Sectional plan(s) 截視圖		✓	
Elevation(s) 立視圖			
Photomontage(s) showing the proposed development 顯示擬議發展的合成照片		$\overline{\checkmark}$	
Master landscape plan(s)/Landscape plan(s) 園境設計總圖/園境設計圖		$\overline{\checkmark}$	
Others (please specify) 其他(請註明)		✓	
位置圖 Location plan			
Reports 報告書 Planning Statement/Justifications 規劃綱領/理據 Environmental assessment (noise, air and/or water pollutions) 環境評估(噪音、空		✓	
氣及/或水的污染) Traffic impact assessment (on vehicles) 就車輛的交通影響評估		7	
Traffic impact assessment (on pedestrians) 就行人的交通影響評估			
Visual impact assessment 視覺影響評估	H	□ ✓	
Landscape impact assessment 景觀影響評估	H		
Tree Survey 樹木調查		7	
Geotechnical impact assessment 土力影響評估		Ē	
Drainage impact assessment 排水影響評估			
Sewerage impact assessment 排污影響評估			
Risk Assessment 風險評估			
Others (please specify) 其他(請註明)		<u></u>	
空氣流通評估 Air Ventilation Assessment			
Note: May insert more than one「✔」. 註:可在多於一個方格內加上「✔」號			

Note: The information in the Gist of Application above is provided by the applicant for easy reference of the general public. Under no circumstances will the Town Planning Board accept any liabilities for the use of the information nor any inaccuracies or discrepancies of the information provided. In case of doubt, reference should always be made to the submission of the applicant.

註: 上述申請摘要的資料是由申請人提供以方便市民大眾參考。對於所載資料在使用上的問題及文義上的歧異,城市規劃委員會概不負責。若有任何疑問,應查閱申請人提交的文件。

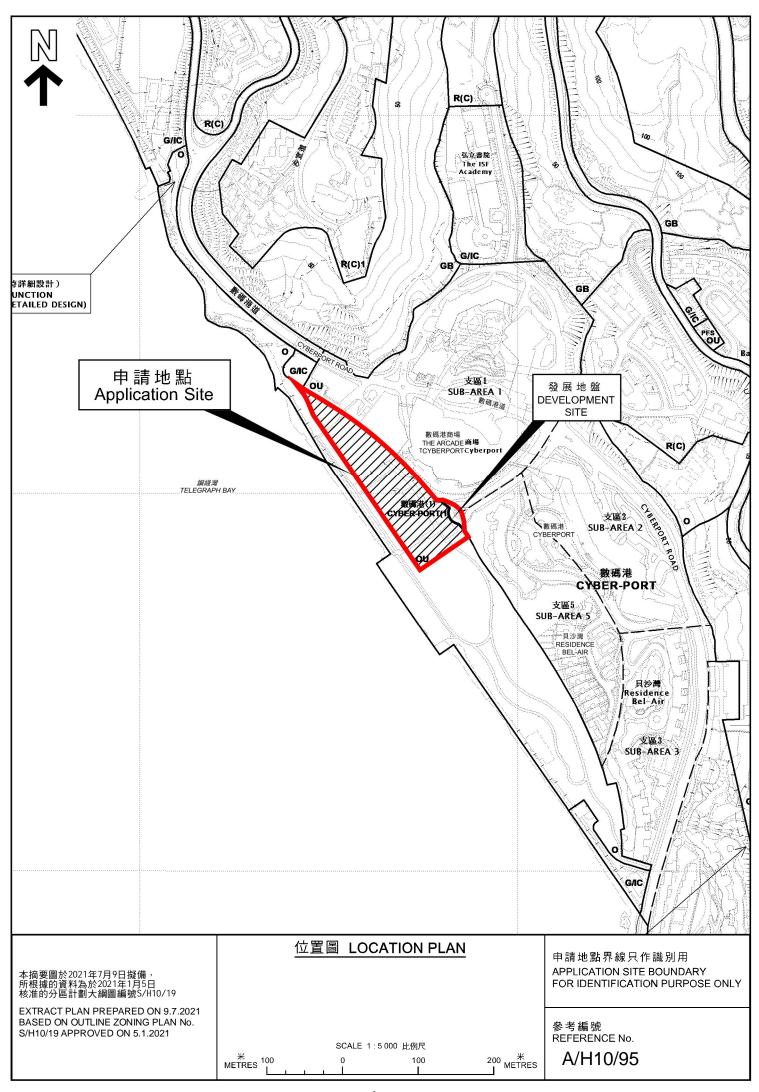

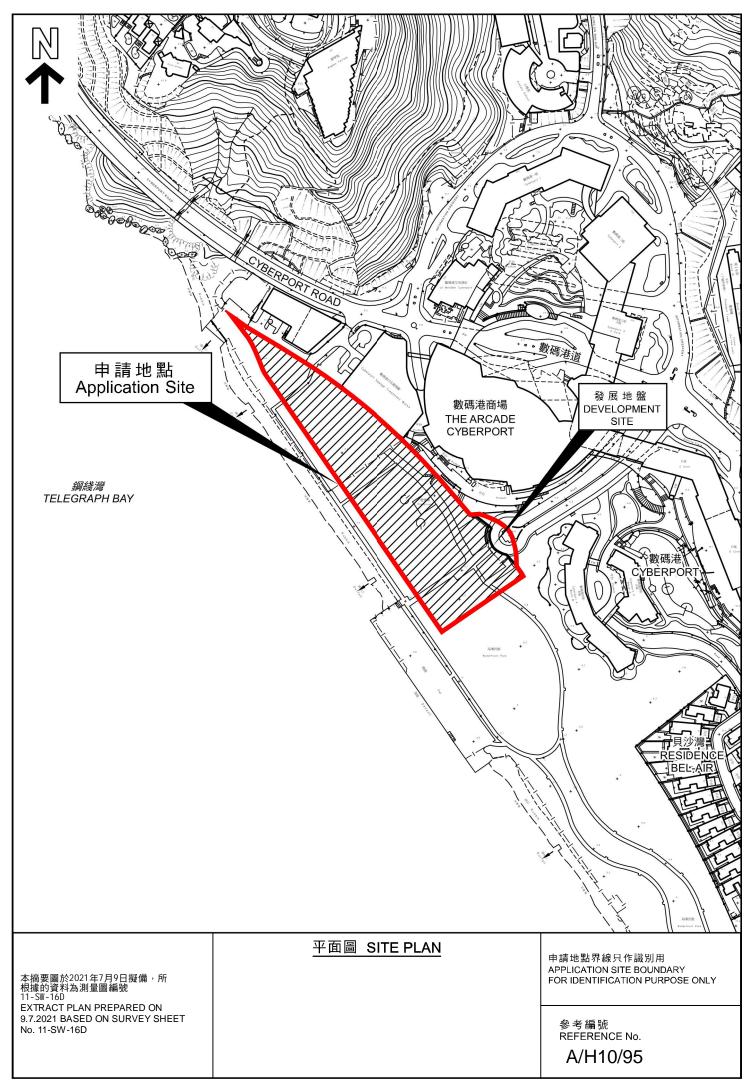

Revision 2.0 - June 2021

申請摘要

背景

香港數碼港管理有限公司(下稱「申請人」)現按城市規劃條例第 16 條,向城市規劃委員會(下稱「城規會」)提交擬議數碼港擴展計劃(下稱「擬議發展」)的發展藍圖。擬議發展的地盤位於薄扶林鋼綫灣一地盤,地盤位處薄扶林分區計劃大綱核准圖編號 S/H10/19 中「其他指定用途」註明「數碼港(1)」地帶。

擬議發展中的用途包括:「食肆」、「展覽或會議廳」、「資訊科技及電訊業」、「辦公室」及「商店及服務行業」,以上用途全屬於「其他指定用途」註明「數碼港(1)」地帶中的第一欄用途,即經常准許的用途。

擬議的發展藍圖

擬議發展將提供最多 66,000 平方米樓面面積,擬議建築物最高點(上層天台)為主水平基準上 58 米, 比起法定圖則中「其他指定用途」註明「數碼港(1)」地帶所限定的最高建築物高度(主水平基準上 65 米) 還要低。

擬議發展主要提供:不少於 5,000 平方米的地面公眾休憩用地;於低層設有商業用途(商店、餐飲、戶外用餐範圍及展示最新資訊科技產品的展示廳)、多功能會議廳、公眾可達的公共空間;數據服務平台設於 4/F;另外,辦公室將設於 1/F、3/F 至 8/F。車路入口設於 G/F,連接資訊道的迴旋處。擬議發展的設計(除 G/F 正門的行人通道外)會鼓勵行人善用於 1/F 新建以連接數碼港商場的行人通道或連接數碼港海濱公園的園境平台。

設計優點及規劃理據

所提交的發展藍圖具備以下設計優點及規劃理據:

- 擬議發展的建築物高度配合薄扶林內陸至海邊一帶的階梯式建築物輪廓;
- 擬議發展的設計與毗鄰的數碼港商場、數碼港海濱公園、海濱長廊及未來用家相互共融;
- 考慮到地盤臨近海濱,擬議發展採用了創新及適切的建築設計;
- 建築設計本身採用了階梯式設計(建築物高度向數碼港海濱公園及南面的海濱長廊逐漸下降);
- 地面及樓上的樓層採用通透式建築設計;
- 除了 5,000 平方米的地面公眾休憩用地,擬議發展更於 1/F 及 2/F 提供更多公眾可達的公共空間, 為公眾帶來裨益;
- 為數碼港商場、海濱公園、海濱長廊及擬議發展之間連接行人通道;
- 各種能讓公眾享受的設施(如:商店、餐飲、戶外用餐範圍、展示廳及多功能會議廳)集中於低層,方便公眾,帶來熱鬧及活躍氣氛;
- 擬議發展提供了多功能的園境空間,以配合公眾的不同用途;
- 透過創新的設計措施,可減低潛在的視覺影響;
- 空氣流通影響評估報告顯示擬議發展不會帶來不良的空氣流通影響;及
- 修訂圖則階段提出的規劃理據,尤其是數碼港擴建的需求,仍然生效。

結論

綜合以上的設計優點及規劃理據,申請人懇請城規會支持是次呈交的發展藍圖。

Revision 2.0 - June 2021

EXECUTIVE SUMMARY

Background

This layout plan submission is prepared and submitted on behalf of the Hong Kong Cyberport Management Company Limited ("HKCMCL") ("the Applicant") to seek approval from the Town Planning Board ("TPB") under section 16 of the Town Planning Ordinance ("TPO") for the layout plan submission for Proposed Cyberport Expansion ("Proposed Development") at Telegraph Bay, Pok Fu Lam, Hong Kong. The Application Site is zoned "Other Specified Uses" annotated "Cyber-Port (1)" ("OU(Cyber-Port)(1)") on the Approved Pok Fu Lam Outline Zoning Plan No. S/H10/19 ("the Approved OZP").

The proposed uses in the Proposed Development including "Eating Place", "Exhibition or Convention Hall", "Information Technology and Telecommunications Industries", "Office" and "Shop and Services". Under the prevailing "OU(Cyber-Port)(1)" zone, all these uses are belonged to "Column 1" uses, which are permitted as of right.

The Proposed Layout Plan

The Proposed Development will yield a total of 66,000m² accountable GFA (at max.). The proposed max. building height (Upper Roof) is 58mPD which is not more than the statutory building height at 65mPD under the prevailing "OU(Cyber-Port)(1)" zone.

The Proposed Development will include at-grade Public Open Space of 5,000m²; commercial floor space (retail, Food and Beverage (F&B) and Alfresco Dining, as well as demonstration hall for exhibition of latest IT products & technology), multi-function hall and publicly accessible area at the lower floors; data services platform at 4/F; and office space (digital tech space) at 1/F, 3/F to 8/F. Vehicular access will be provided at G/F via the roundabout at the end of Information Crescent, while pedestrian connections (in addition to the main entrance at G/F) are encouraged at 1/F of the Proposed Development via the proposed connection with The Arcade Cyberport via a linkbridge or the landscape deck with elevated walkway connecting to Waterfront Park.

Design Merits and Planning Justifications


The layout plan of the proposed development scheme is well justified with the following design merits and planning justifications:

- Proposed building height being considered compatible with the stepped height profile intended for the area from the inner part of Pok Fu Lam to the waterfront;
- Being integrated with the adjoining Cyberport Development, Cyberport Waterfront Park,
 Waterfront Promenade as well as future users;
- Introducing innovative and responsive building design for Proposed Development near the waterfront;
- Maintaining terraced building design with stepped building height lowering towards Cyberport

- Waterfront Park and the waterfront promenade to the south;
- Maintaining permeable building design on ground and upper floors;
- Introducing enhanced provision of publicly accessible area at multi-levels, including not less than 5,000m² of at-grade public open space, and additional publicly accessible area at 1/F and 2/F;
- Establishing pedestrian connectivity among The Arcade Cyberport, Cyberport Waterfront Park with the promenade, as well as the Proposed Development;
- Centralizing various facilities (such as retail, F&B, Alfresco Dining, demonstration hall and multi-function hall) at the lower floors of the Proposed Development for public enjoyment and enhancing vibrancy;
- Provision of multi-functional open landscaped area to allow diverse uses by the public;
- Incorporation of innovative design measures to minimize any potential visual impact;
- No adverse air ventilation impact being anticipated as revealed from the Air Ventilation Assessment; and
- The previous planning justifications particularly the need for expansion being still valid.

Conclusion


Based on the above design merits and planning justifications, the Applicant sincerely requests the TPB to give favourable consideration to this layout plan submission.

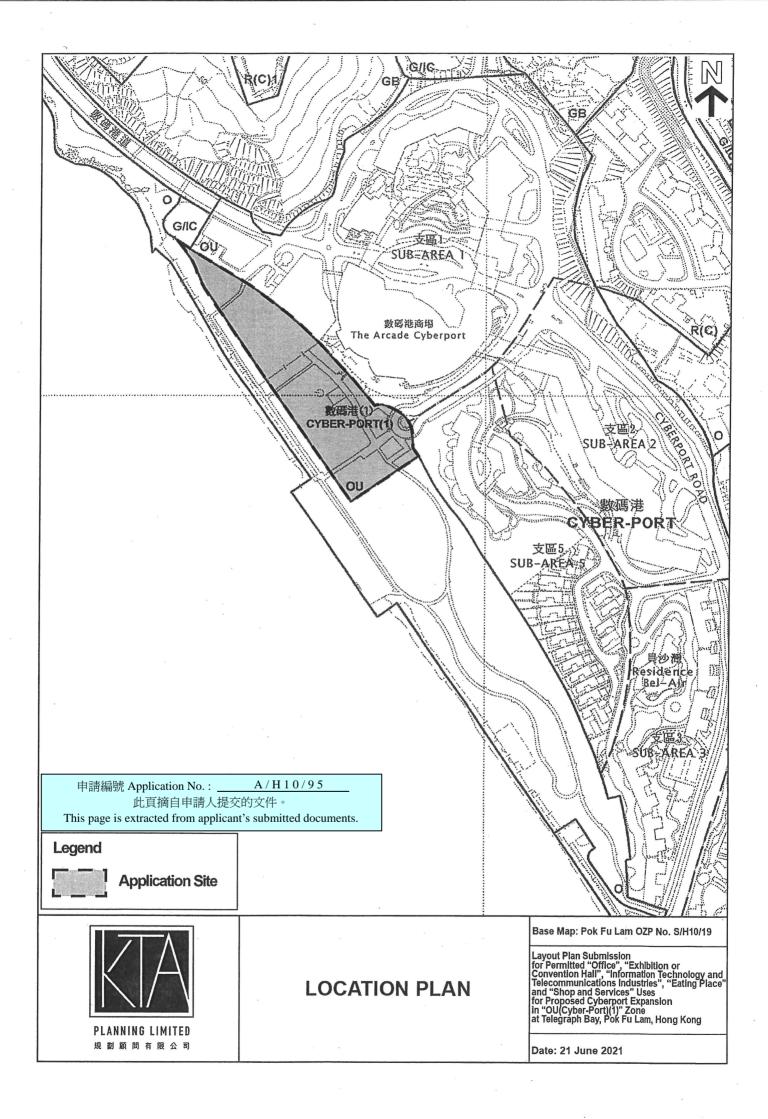

Revision 2.0 - June 2021



Figure 2.2.3 Illustrative Image of the Proposed Development – Iconic Building near the Waterfront (The landscape design of the existing Promenade and the Waterfront Park is indicative and for reference only)

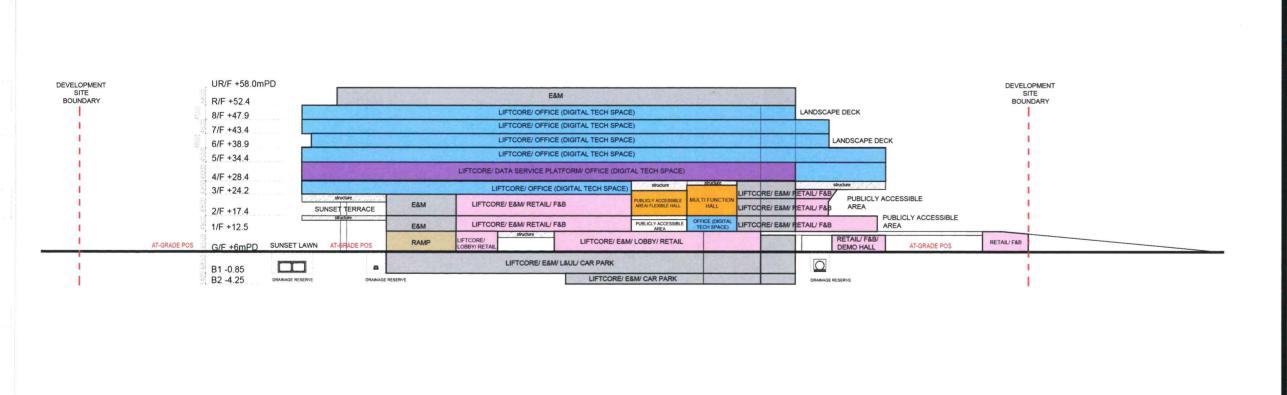

E&M/ CARPARK/ LOADING & UNLOADING BAY

RAMP

RETAIL/ F&B

A/H10/95

申請編號 Application No.:

此頁摘自申請人提交的文件。 This page is extracted from applicant's submitted documents. MULTI-FUNCTION HALL

DATA SERVICE PLATFORM

OFFICE (DIGITAL TECH SPACE)

DEVELOPMENT SITE BOUNDARY


DRAINAGE RESERVE (D.R.)

This drawing and the contents herein are the copyright of Rocco Design Architects Limited. 本圖紙及其內容的版權屬許李嚴建築師事務有限公司所有。 No part of the drawing and the design contained herein may be reproduced without the prior written consent of a director of Rocco Design Architects Limited. 未經本公司董事書面同意,不得複製此圖紙內任何內容或設計。 Do not take measurements directly from this drawing. 切勿直接從圖紙上量度尺寸。 Check and verify all dimensions on site. 所有尺寸必須在工地現場複查及審核。 Read this drawing in conjunction with the specifications and all other related drawings. 此圖紙必須與規格說明書及其它有關圖紙一併閱讀。 Notify the Architect immediately of any discrepancy found herein. 如發現內容有任何謬誤之處,應立刻通知建築師。 Client 業主 Hong Kong Cyberport Management Company Limited Proposed Cyberport Expansion in "OU(CYBER-PORT)(1)" zone Drawing Title 圖名 Section Scale 比例 Checked 校對 Drawn 製圖 1:1200 (A3) Job No. 項目編號 Drawing No. 圖號 Revision 修改版 Q

Revision/Submission 修改版/報批

Date日期 Approved 審定

No.編號 Description說明

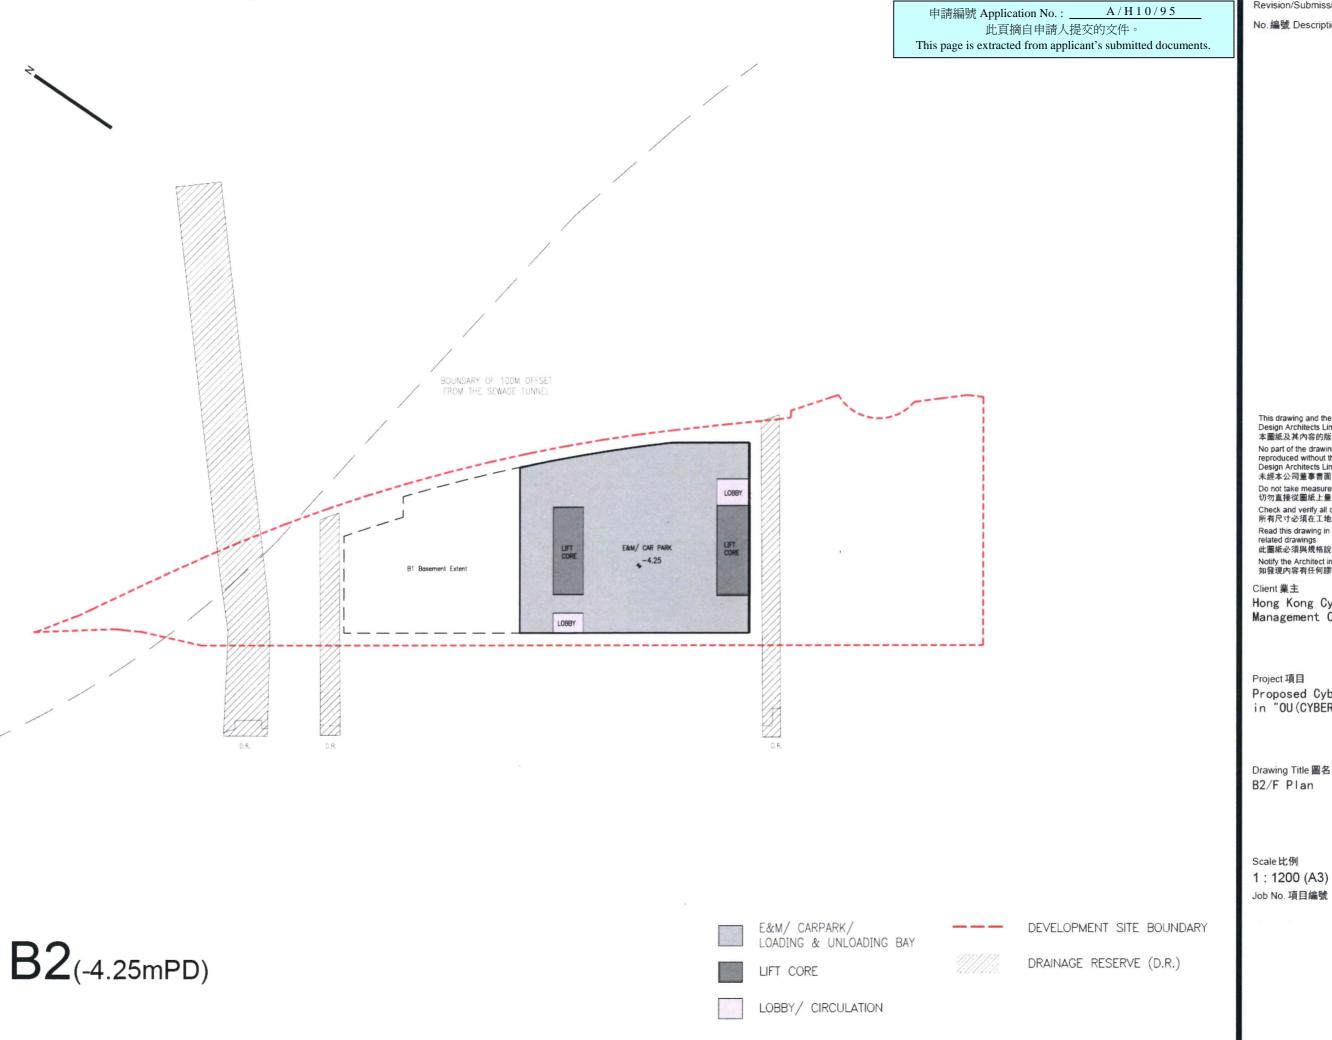

Revision/Submission 修改版/報批

No.編號 Description說明

Date日期 Approved 審定

This drawing and the contents herein are the copyright of Rocco Design Architects Limited. 本圖紙及其內容的版權屬許李嚴建築師事務有限公司所有。

中国職人及共行各の政権機能子を歴史的学が可収と可が行る。
No part of the drawing and the design contained herein may be reproduced without the prior written consent of a director of Rocco Design Architects Limited.
未經本公司董事書面同意,不得複製此圖紙內任何內容或設計。

Do not take measurements directly from this drawing. 切勿直接從圖紙上量度尺寸。

Check and verify all dimensions on site. 所有尺寸必須在工地現場複查及審核。

Read this drawing in conjunction with the specifications and all other related drawings. 此圖紙必須與規格說明書及其它有關圖紙一併閱讀。

Notify the Architect immediately of any discrepancy found herein. 如發現內容有任何謬誤之處,應立刻通知建築師。

Hong Kong Cyberport Management Company Limited

Proposed Cyberport Expansion in "OU (CYBER-PORT) (1)" zone

Drawing Title 圖名

Checked 校對

Job No. 項目編號 Drawing No. 圖號 Revision 修改版

Revision/Submission 修改版/報批

No.編號 Description說明

Date日期 Approved 審定

This drawing and the contents herein are the copyright of Rocco Design Architects Limited. 本圖紙及其內容的版權屬許李嚴建築師事務有限公司所有。

No part of the drawing and the design contained herein may be reproduced without the prior written consent of a director of Rocco Design Architects Limited.

未經本公司董事書面同意,不得複製此圖紙內任何內容或設計。

Do not take measurements directly from this drawing. 切勿直接從圖紙上量度尺寸。

Check and verify all dimensions on site. 所有尺寸必須在工地現場接查及審核。

Read this drawing in conjunction with the specifications and all other related drawings. 此圖紙必須與規格說明書及其它有關圖紙一併閱讀。

Notify the Architect immediately of any discrepancy found herein. 如發現內容有任何謬誤之處,應立刻通知建築師。

Hong Kong Cyberport Management Company Limited

Proposed Cyberport Expansion in "OU(CYBER-PORT)(1)" zone


Drawing Title 圖名 B1/F Plan


Scale 比例 Drawn 製圖


Checked 校對

1:1200 (A3)

Job No. 項目編號 Drawing No. 圖號 Revision 修改版 💡

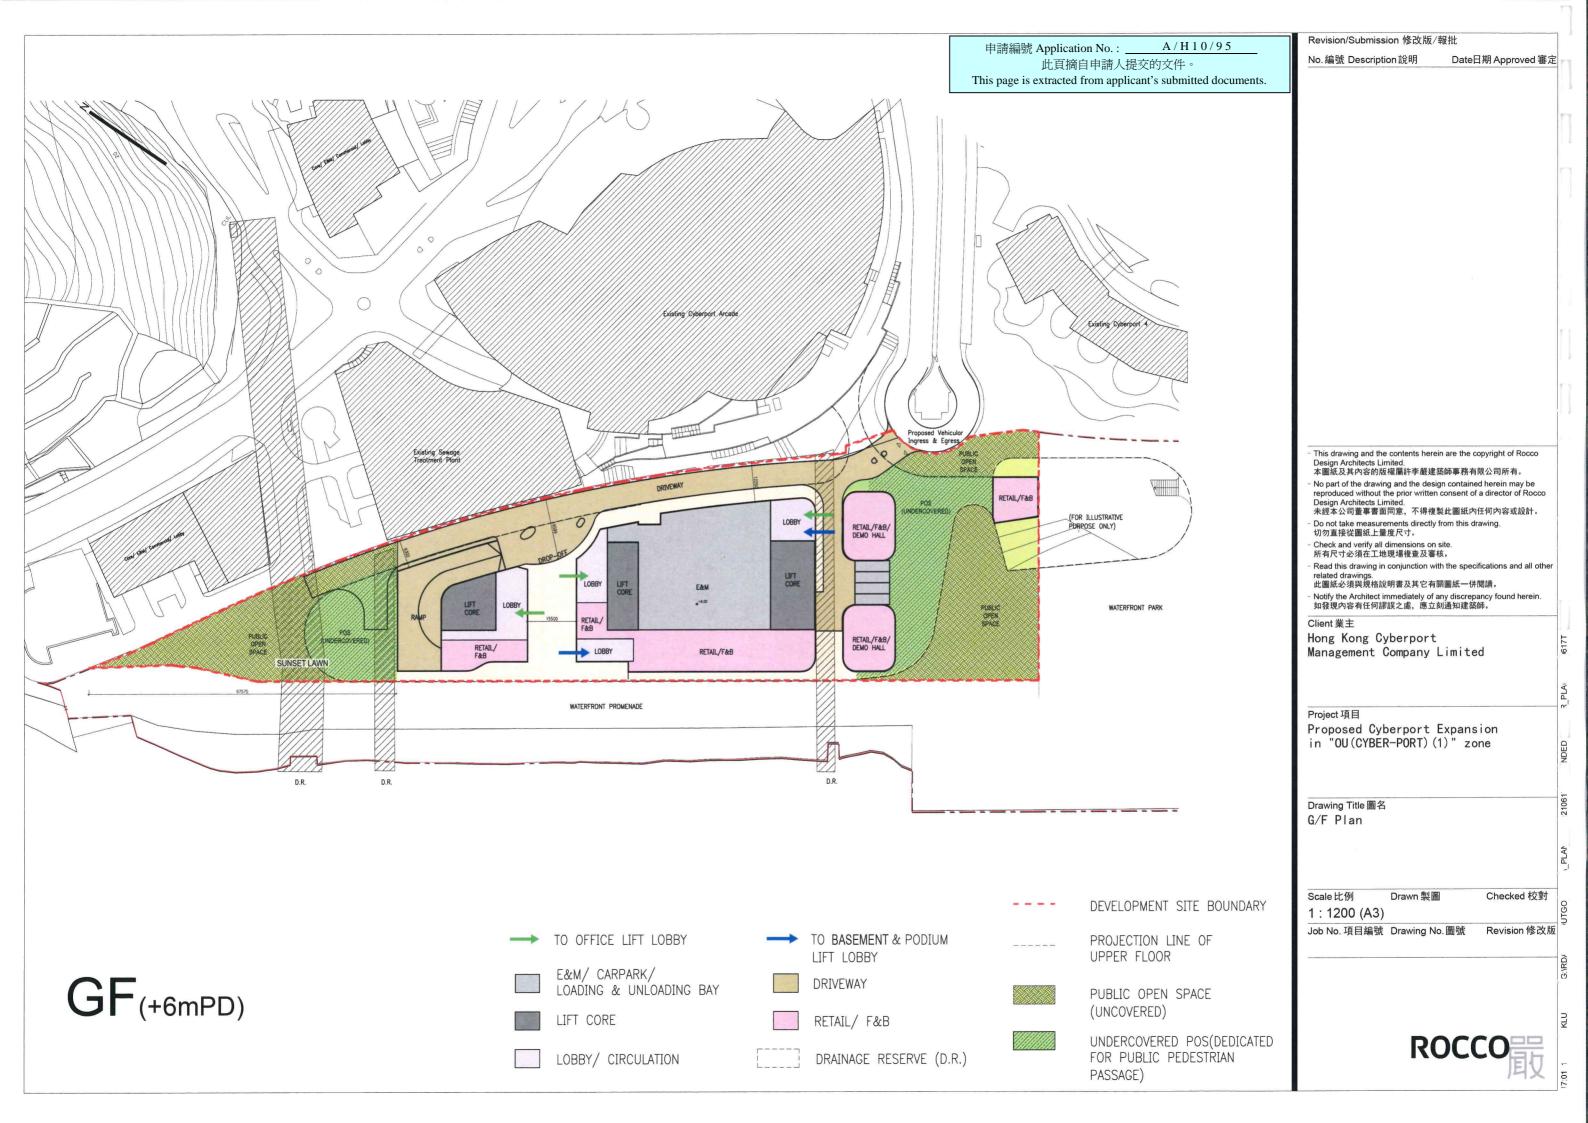

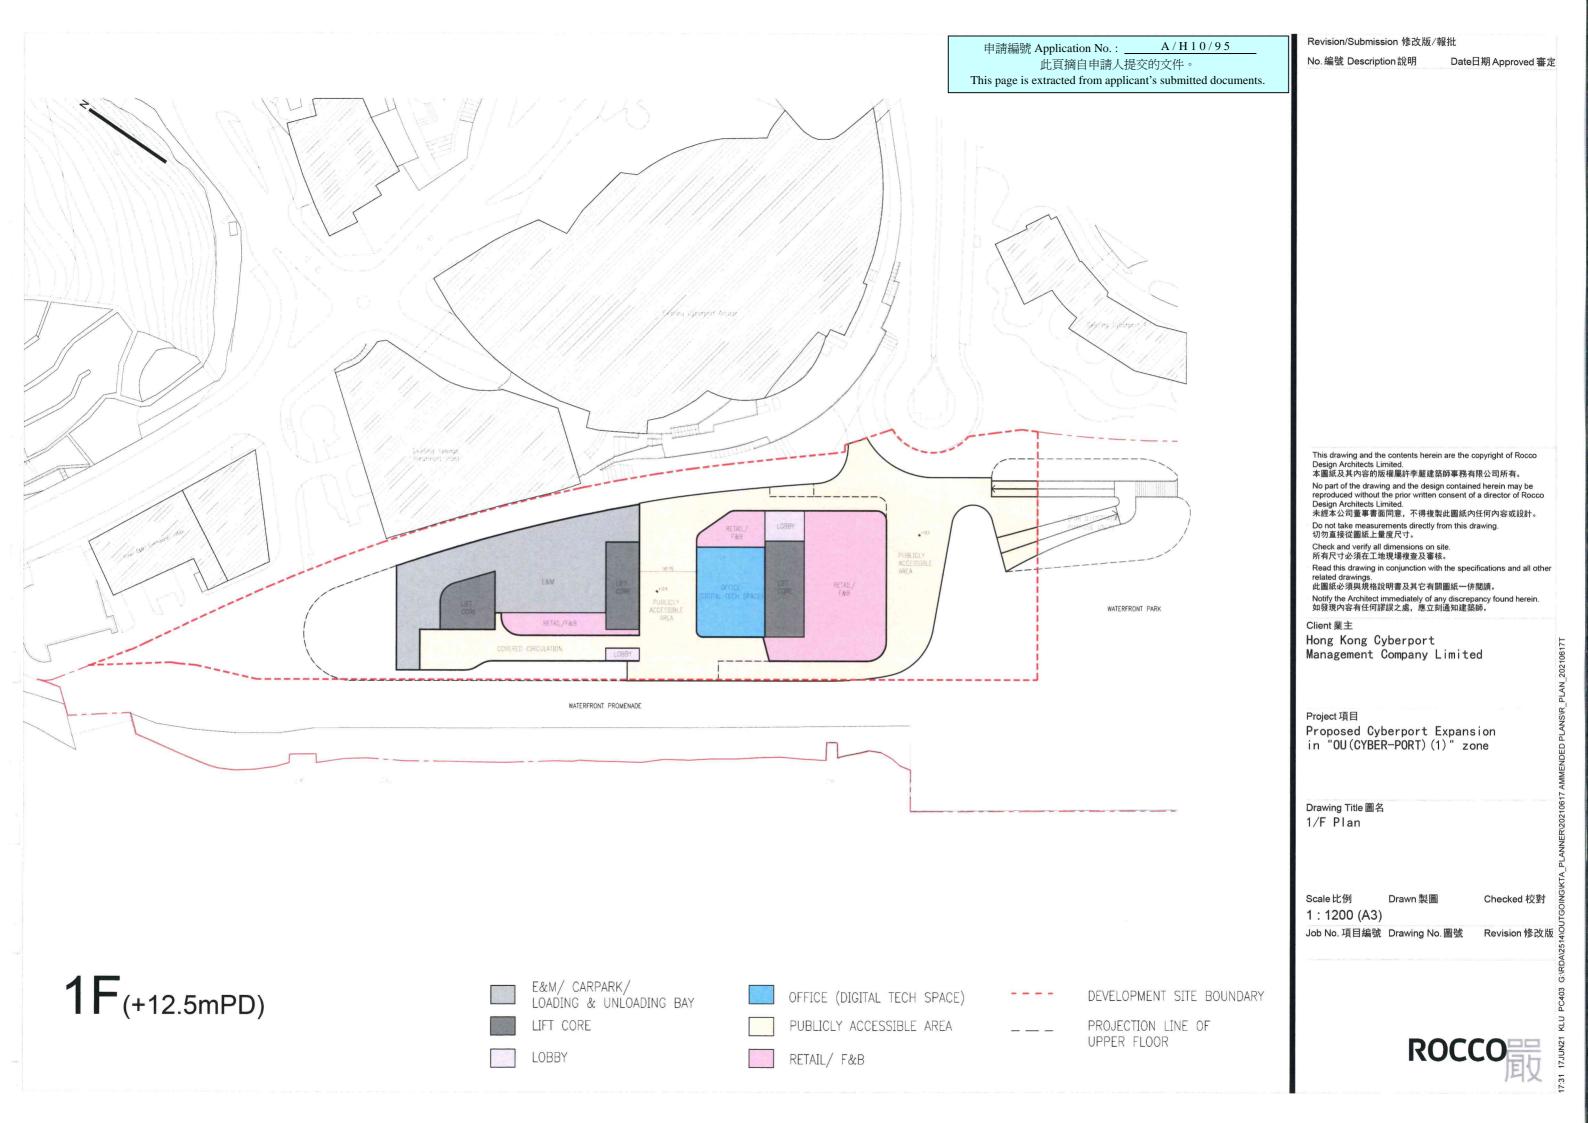

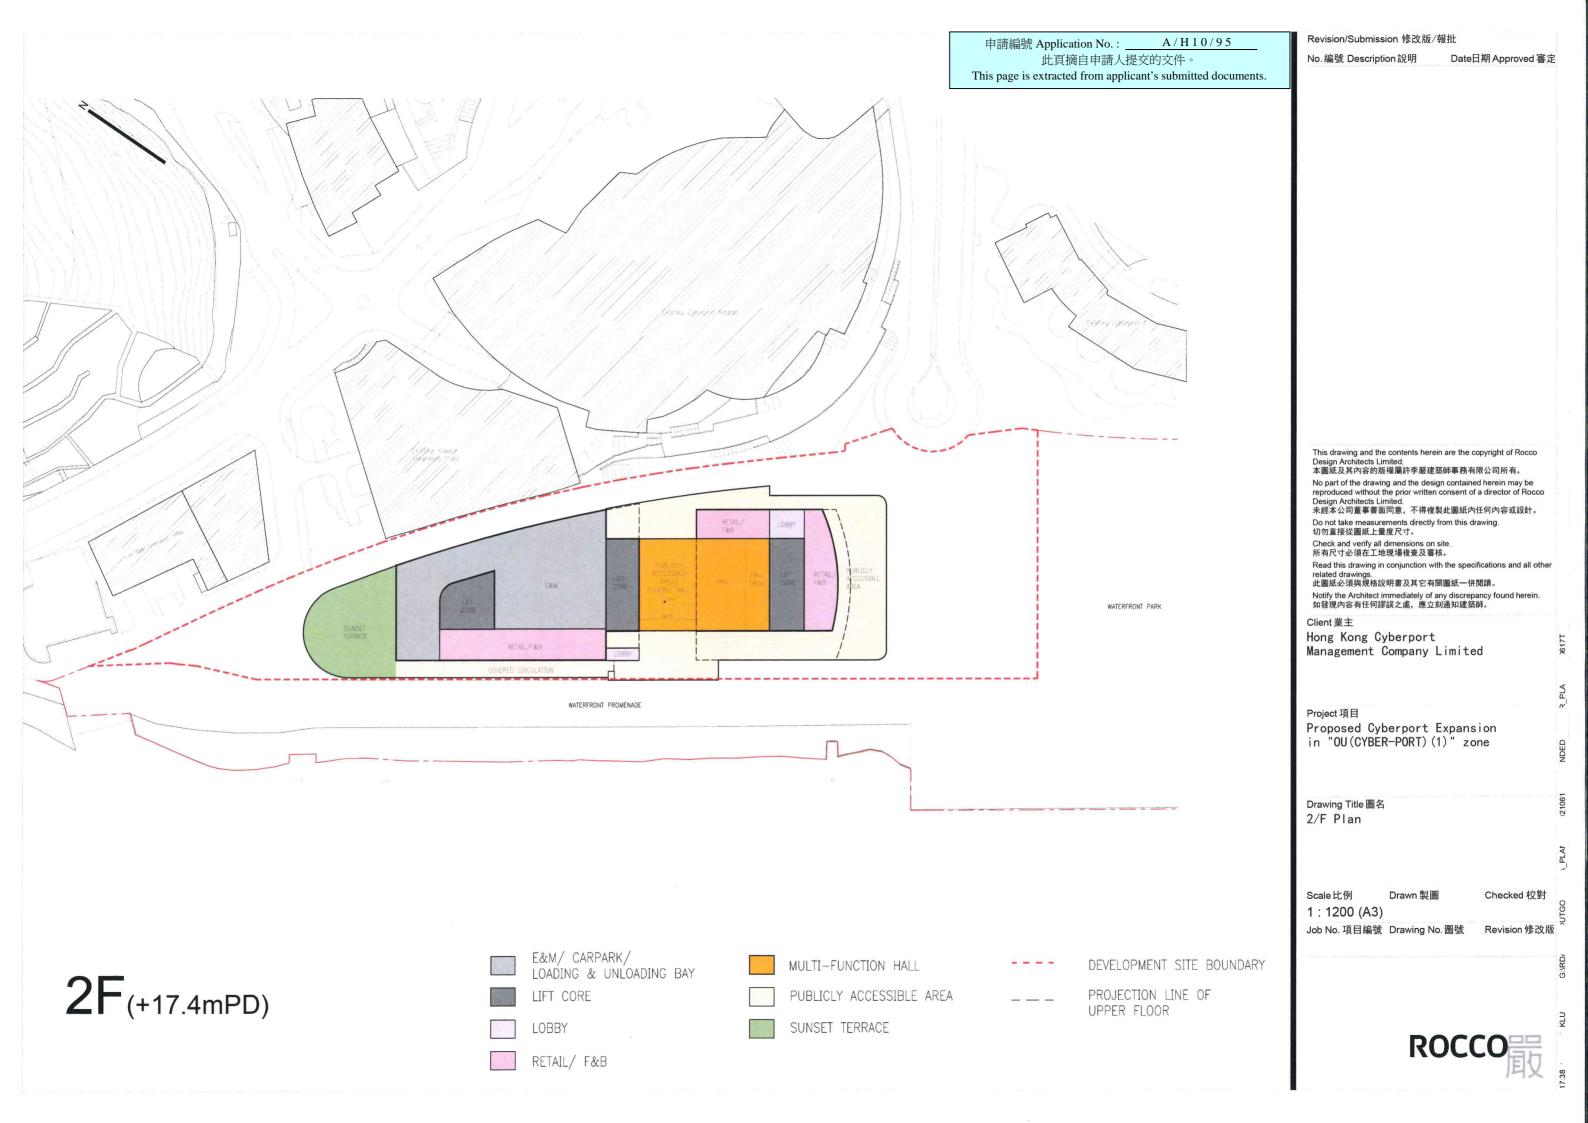

申請編號 Application No.: A/H10/95 此頁摘自申請人提交的文件。

This page is extracted from applicant's submitted documents.

Revision/Submission 修改版/報批

No.編號 Description說明 Date日期 Approved 審定

This drawing and the contents herein are the copyright of Rocco Design Architects Limited. 本圖紙及其內容的版權屬許李嚴建築師事務有限公司所有。

No part of the drawing and the design contained herein may be reproduced without the prior written consent of a director of Rocco Design Architects Limited.
未經本公司董事書面同意,不得複製此圖紙內任何內容或設計。

Do not take measurements directly from this drawing. 切勿直接從圖紙上量度尺寸。

Check and verify all dimensions on site. 所有尺寸必須在工地現場複查及審核。

Read this drawing in conjunction with the specifications and all other related drawings. 此圖紙必須與規格說明書及其它有關圖紙一併閱讀。

Notify the Architect immediately of any discrepancy found herein. 如發現內容有任何謬誤之處,應立刻通知建築師。

Hong Kong Cyberport Management Company Limited

Proposed Cyberport Expansion in "OU(CYBER-PORT)(1)" zone

Drawing Title 圖名 3/F Plan

Scale 比例

Checked 校對

1:1200 (A3)

Job No. 項目編號 Drawing No. 圖號

Revision 修改版 🖁

3F(+24.2mPD)

E&M/ CARPARK/ LOADING & UNLOADING BAY LIFT CORE

OFFICE (DIGITAL TECH SPACE)

RETAIL/ F&B

PROJECTION LINE OF UPPER FLOOR


A/H10/95 申請編號 Application No.: ____ 此頁摘自申請人提交的文件。

This page is extracted from applicant's submitted documents.

Revision/Submission 修改版/報批

No.編號 Description說明

Date日期 Approved 審定

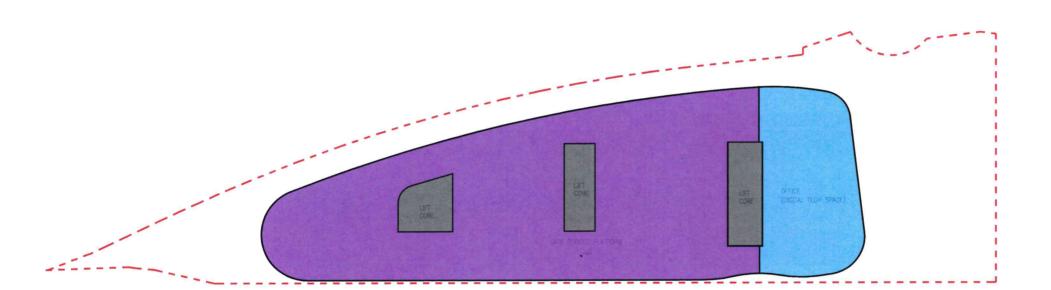

This drawing and the contents herein are the copyright of Rocco Design Architects Limited. 本圖紙及其內容的版權屬許李嚴建築師事務有限公司所有。 No part of the drawing and the design contained herein may be

reproduced without the prior written consent of a director of Rocco Design Architects Limited. 未經本公司董事書面同意,不得複製此圖紙內任何內容或設計。 Do not take measurements directly from this drawing. 切勿直接從圖紙上量度尺寸。

Check and verify all dimensions on site. 所有尺寸必須在工地現場複查及審核。

Read this drawing in conjunction with the specifications and all other related drawings. 此圖紙必須與規格說明書及其它有關圖紙一併閱讀。

Notify the Architect immediately of any discrepancy found herein. 如發現內容有任何謬誤之處,應立刻通知建築師。

Client 業主

Hong Kong Cyberport Management Company Limited

Project 項目 Proposed Cyberport Expansion in "OU(CYBER-PORT)(1)" zone

Drawing Title 圖名 4/F Plan

Scale 比例 Checked 校對

1:1200 (A3)

Job No. 項目編號 Drawing No. 圖號 Revision 修改版

 $4F_{(+28.4mPD)}$



OFFICE (DIGITAL TECH SPACE)


申請編號 Application No.: A/H10/95 此頁摘自申請人提交的文件。

This page is extracted from applicant's submitted documents.

Revision/Submission 修改版/報批

No.編號 Description說明

Date日期 Approved 審定

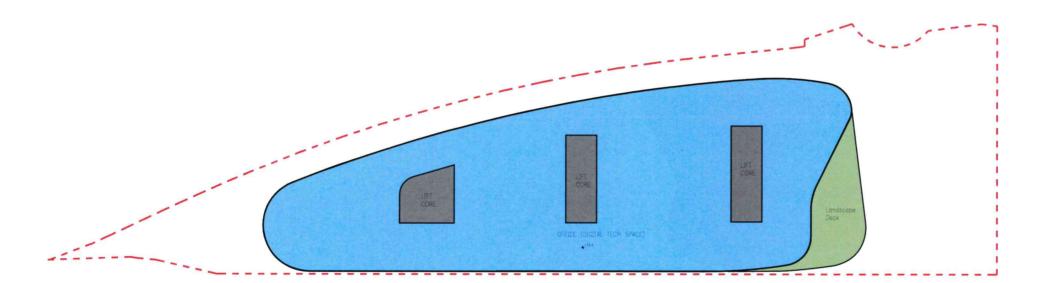

This drawing and the contents herein are the copyright of Rocco Design Architects Limited. 本圖紙及其內容的版權屬許李嚴建築師事務有限公司所有。

No part of the drawing and the design contained herein may be reproduced without the prior written consent of a director of Rocco Design Architects Limited.
未經本公司董事書面同意,不得複製此圖紙內任何內容或設計。

Do not take measurements directly from this drawing. 切勿直接從圖紙上量度尺寸。

Check and verify all dimensions on site 所有尺寸必須在工地現場複查及審核。

Read this drawing in conjunction with the specifications and all other related drawings. 此圖紙必須與規格說明書及其它有關圖紙一併閱讀。

Notify the Architect immediately of any discrepancy found herein. 如發現內容有任何謬誤之處,應立刻通知建築師。

Hong Kong Cyberport Management Company Limited

Proposed Cyberport Expansion in "OU(CYBER-PORT)(1)" zone

Drawing Title 圖名 5/F Plan

Scale 比例

Checked 校對

1:1200 (A3)

Job No. 項目編號 Drawing No. 圖號

Revision 修改版 ?

5F(+34.4mPD)

LIFT CORE LANDSCAPE DECK OFFICE (DIGITAL TECH SPACE)

Revision/Submission 修改版/報批 申請編號 Application No.: A/H10/95 No.編號 Description說明 此頁摘自申請人提交的文件。 This page is extracted from applicant's submitted documents. 6F(+38.9mPD) OFFICE (DIGITAL TECH SPACE) LIFT CORE DEVELOPMENT SITE BOUNDARY

LANDSCAPE DECK

This drawing and the contents herein are the copyright of Rocco Design Architects Limited. 本圖紙及其內容的版權屬許李嚴建築師事務有限公司所有。 No part of the drawing and the design contained herein may be reproduced without the prior written consent of a director of Rocco Design Architects Limited.
未經本公司董事書面同意,不得複製此圖紙內任何內容或設計。 Do not take measurements directly from this drawing. 切勿直接從圖紙上量度尺寸。 Check and verify all dimensions on site. 所有尺寸必須在工地現場複查及審核。 Read this drawing in conjunction with the specifications and all other related drawings. 此圖紙必須與規格說明書及其它有關圖紙一併閱讀。 Notify the Architect immediately of any discrepancy found herein 如發現內容有任何謬誤之處,應立刻通知建築師。 Client 業主 Hong Kong Cyberport Management Company Limited Project 項目 Proposed Cyberport Expansion in "OU(CYBER-PORT)(1)" zone Drawing Title 圖名 6/F Plan Scale比例 1:1200 (A3) Job No. 項目編號 Drawing No. 圖號 Revision 修改版

Date日期 Approved 審定

申請編號 Application No.: A/H10/95 此頁摘自申請人提交的文件。

This page is extracted from applicant's submitted documents.

Revision/Submission 修改版/報批

No.編號 Description說明 Date日期 Approved 審定

This drawing and the contents herein are the copyright of Rocco Design Architects Limited. 本圖紙及其內容的版權屬許李嚴建築師事務有限公司所有。

No part of the drawing and the design contained herein may be reproduced without the prior written consent of a director of Rocco Design Architects Limited.
未經本公司董事書面同意,不得複製此圖紙內任何內容或設計。

Do not take measurements directly from this drawing. 切勿直接從圖紙上量度尺寸。

Check and verify all dimensions on site. 所有尺寸必須在工地現場複查及審核。

Read this drawing in conjunction with the specifications and all other related drawings. 此圖紙必須與規格說明書及其它有關圖紙一併閱讀。

Notify the Architect immediately of any discrepancy found herein. 如發現內容有任何謬誤之處,應立刻通知建築師。

Hong Kong Cyberport Management Company Limited

Proposed Cyberport Expansion in "OU(CYBER-PORT)(1)" zone

Drawing Title 圖名 7/F Plan

Scale 比例

Checked 校對

1:1200 (A3)

Job No. 項目編號 Drawing No. 圖號 Revision 修改版 🖁

7F(+43.4mPD)

LIFT CORE LANDSCAPE DECK OFFICE (DIGITAL TECH SPACE)

申請編號 Application No.: A/H10/95 此頁摘自申請人提交的文件。 This page is extracted from applicant's submitted documents. Scale 比例 $8F_{\text{(+47.9mPD)}}$ OFFICE (DIGITAL TECH SPACE) DEVELOPMENT SITE BOUNDARY LIFT CORE LANDSCAPE DECK

Revision/Submission 修改版/報批 No. 編號 Description 說明 Date日期 Approved 審定

This drawing and the contents herein are the copyright of Rocco Design Architects Limited. 本圖紙及其內容的版權屬許李嚴建築師事務有限公司所有。

No part of the drawing and the design contained herein may be reproduced without the prior written consent of a director of Rocco Design Architects Limited. 未經本公司董事書面同意,不得複製此圖紙內任何內容或設計。

Do not take measurements directly from this drawing. 切勿直接從圖紙上量度尺寸。

Check and verify all dimensions on site 所有尺寸必須在工地現場複查及審核。

Read this drawing in conjunction with the specifications and all other related drawings.
此圖紙必須與規格說明書及其它有關圖紙一併閱讀。

Notify the Architect immediately of any discrepancy found herein. 如發現內容有任何謬誤之處,應立刻通知建築師。

Client 業主

Hong Kong Cyberport Management Company Limited

Proposed Cyberport Expansion in "OU(CYBER-PORT)(1)" zone

Drawing Title 圖名 8/F Plan

Checked 校對

1:1200 (A3)

Job No. 項目編號 Drawing No. 圖號 Revision 修改版

申請編號 Application No.: A/H10/95 此頁摘自申請人提交的文件。 This page is extracted from applicant's submitted documents. Revision/Submission 修改版/報批

Date日期 Approved 審定 No.編號 Description說明

This drawing and the contents herein are the copyright of Rocco Design Architects Limited. 本圖紙及其內容的版權屬許李嚴建築師事務有限公司所有。

No part of the drawing and the design contained herein may be reproduced without the prior written consent of a director of Rocco Design Architects Limited.

未經本公司董事書面同意,不得複製此圖紙內任何內容或設計。

Do not take measurements directly from this drawing. 切勿直接從圖紙上量度尺寸。

Check and verify all dimensions on site. 所有尺寸必須在工地現場複查及審核。

Read this drawing in conjunction with the specifications and all other related drawings.
此圖紙必須與規格說明書及其它有關圖紙一併閱讀。

Notify the Architect immediately of any discrepancy found herein. 如發現內容有任何謬誤之處,應立刻通知建築師。

Hong Kong Cyberport Management Company Limited

Proposed Cyberport Expansion in "OU(CYBER-PORT)(1)" zone

Drawing Title 圖名 R/F Plan

Checked 校對

1:1200 (A3)

Scale 比例

Job No. 項目編號 Drawing No. 圖號

Revision 修改版 🖁

 $RF_{(+52.4mPD)}$


LIFT CORE

LANDSCAPE DECK

A/H10/95 申請編號 Application No.: ____ 此頁摘自申請人提交的文件。 This page is extracted from applicant's submitted documents.

Revision/Submission 修改版/報批

No.編號 Description說明 Date日期 Approved 審定

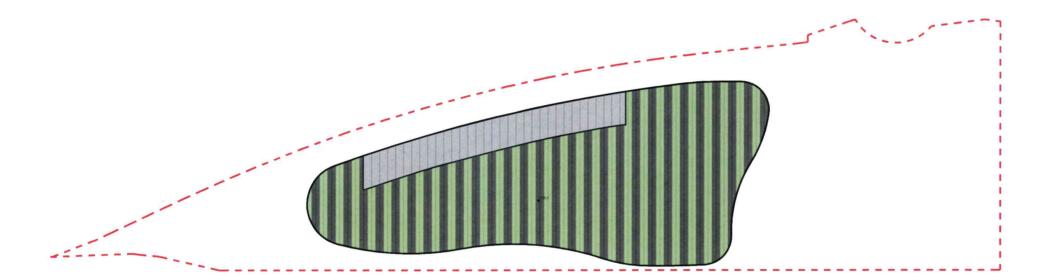

This drawing and the contents herein are the copyright of Rocco Design Architects Limited. 本圖紙及其內容的版權屬許李嚴建築師事務有限公司所有。

No part of the drawing and the design contained herein may be reproduced without the prior written consent of a director of Rocco Design Architects Limited.
未經本公司董事書面同意,不得複製此圖紙內任何內容或設計。

Do not take measurements directly from this drawing. 切勿直接從圖紙上量度尺寸。

Check and verify all dimensions on site. 所有尺寸必須在工地現場複查及審核。

Read this drawing in conjunction with the specifications and all other related drawings. 此圖紙必須與規格說明書及其它有關圖紙一併閱讀。

Notify the Architect immediately of any discrepancy found herein. 如發現內容有任何謬誤之處,應立刻通知建築師。

Client 業主

Hong Kong Cyberport Management Company Limited

Project 項目

Proposed Cyberport Expansion in "OU(CYBER-PORT)(1)" zone

Drawing Title 圖名 UR/F Plan

Scale 比例

1:1200 (A3) Job No. 項目編號 Drawing No. 圖號 Revision 修改版


 $\mathsf{URF}_{(+58.0\mathsf{mPD})}$



Notional Scheme (at 65mPD)

A/H10/95



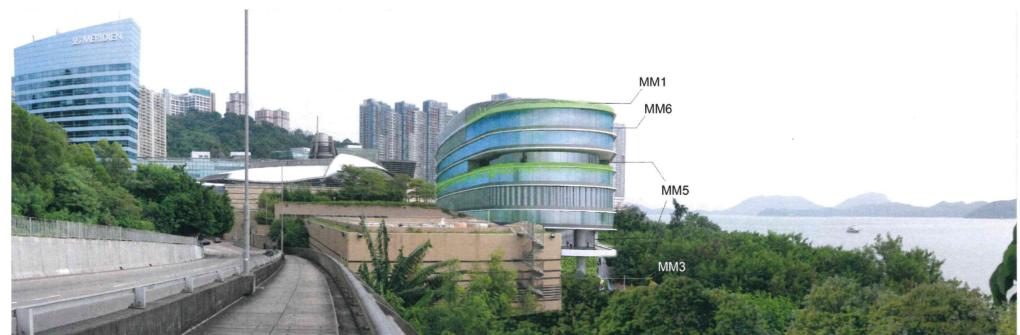

Key Plan

Visual Mitigation Measures:

MM1: Restricting the height of the rooftop structures at not more than 58mPD

MM2: Cascading building height

MM3: Maintaining visual permeability by providing communal garden and at-grade covered POS under high headroom

MM4: Elevated walkway from at-grade level of the Park with Elevated walkway from at-grade level of the Park with Elevated walkway from at-grade level of the Park with Curvy profile and scape decks at different levels with curvy profile to mitigate the scale and soften the edge MM6: Using building materials with the appearance of lightweight and treatment with natural colors

This drawing and the contents herein are the copyright of Rocco Design Architects Limited. 本圖紙及其內容的版權屬許李嚴建築師事務有限公司所有。

No part of the drawing and the design contained herein may be reproduced without the prior written consent of a director of Rocco Design Architects Limited.
未經本公司董事書面同意,不得複製此圖紙內任何內容或設計。

Do not take measurements directly from this drawing. 切勿直接從圖紙上量度尺寸。

Check and verify all dimensions on site. 所有尺寸必須在工地現場複查及審核。

Read this drawing in conjunction with the specifications and all other related drawings. 此圖紙必須與規格說明書及其它有關圖紙一併閱讀。

Notify the Architect immediately of any discrepancy found herein. 如發現內容有任何謬誤之處,應立刻通知建築師。

Hong Kong Cyberport Management Company Limited

2019 Rezoning Scheme (at 61mPD)

Project 項目

Proposed Cyberport Expansion in "OU(Cybert-Port)(1)" zone at Telegraph Bay, Pok Fu Lam, Hong Kong – Layout Plan Submission

Visual Impact Assessment

Drawing Title 圖名

Figure 6.1

Photomontages at VP1 -Footpath along Cyberport Road

Scale 比例 Drawn 製圖 Checked 校對


Job No. 項目編號 Drawing No. 圖號 Revision 修改版

ROCCO







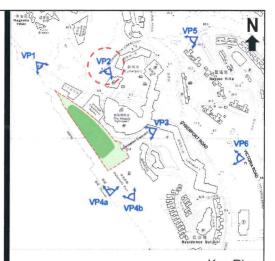

ley Plan

Visual Mitigation Measures:

MM1: Restricting the height of the rooftop structures at not more than 58mPD

MM2: Cascading building height

MM3: Maintaining visual permeability by providing communal garden and at-grade covered POS under high headroom

MM4: Elevated walkway from at-grade level of the Park with the landscape deck at 1/F of Proposed Development MM5: Providing landscape decks at different levels with curvy profile to mitigate the scale and soften the edge MM6: Using building materials with the appearance of lightweight and treatment with natural colors

This drawing and the contents herein are the copyright of Rocco Design Architects Limited. 本圖紙及其內容的版權屬許李嚴建築師事務有限公司所有。

- No part of the drawing and the design contained herein may be reproduced without the prior written consent of a director of Rocco Design Architects Limited.
未經本公司董事書面同意,不得複製此圖紙內任何內容或設計。

未經本公司董事書面同意,不得複製此圖紙內任何內容或設置 Do not take measurements directly from this drawing. 切勿直接從圖紙上量度尺寸。

Check and verify all dimensions on site. 所有尺寸必須在工地現場複查及審核。

Read this drawing in conjunction with the specifications and all other related drawings.
此圖紙必須與規格說明書及其它有關圖紙一併閱讀。

此圖紙必須與規格說明書及其它有關圖紙一併閱讚。 - Notify the Architect immediately of any discrepancy found herein. 如發現內容有任何謬誤之處,應立刻通知建築師。

Client 業主

Hong Kong Cyberport Management Company Limited

2019 Rezoning Scheme (at 61mPD)

Notional Scheme (at 65mPD)

Project 項目

Proposed Cyberport Expansion in "OU(Cybert-Port)(1)" zone at Telegraph Bay, Pok Fu Lam, Hong Kong – Layout Plan Submission

Visual Impact Assessment

Drawing Title 圖名

Figure 6.2
Photomontages at VP2 Footpath along Information Crescent adjacent to Cyberport 1

Scale 比例 Drawn 製圖 Checked 校對 N/A


Job No. 項目編號 Drawing No. 圖號


號 Revision 修改版

ROCCO





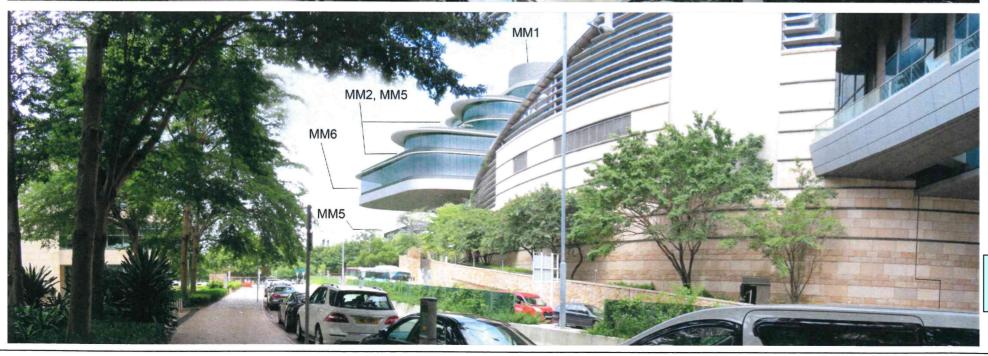

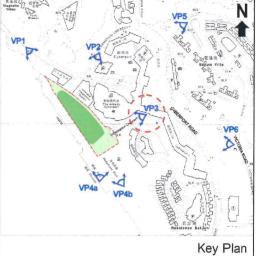

Visual Mitigation Measures: MM1: Restricting the height of the rooftop structures at not more than 58mPD

at not more than 58mPD
MM2: Cascading building height
MM3: Maintaining visual permeability by providing
communal garden and at-grade covered POS
under high headroom
MM4: Elevated walkway from at-grade level of the Park
with the landscape deck at 1/F of Proposed Development
MM5: Providing landscape decks at different levels
with curvy profile to mitigate the scale and soften the edge
MM6: Using building materials with the appearance of
lightweight and treatment with natural colors

This drawing and the contents herein are the copyright of Rocco Design Architects Limited. 本圖紙及其內容的版權屬許李嚴建築師事務有限公司所有。

No part of the drawing and the design contained herein may be reproduced without the prior written consent of a director of Rocco Design Architects Limited.
未經本公司董事書面同意,不得複製此圖紙內任何內容或設計。

Do not take measurements directly from this drawing. 切勿直接從圖紙上量度尺寸。

Check and verify all dimensions on site. 所有尺寸必須在工地現場複查及審核。

Read this drawing in conjunction with the specifications and all other related drawings. 此圖紙必須與規格說明書及其它有關圖紙一併閱讀。

Notify the Architect immediately of any discrepancy found herein. 如發現內容有任何謬誤之處,應立刻通知建築師。

Hong Kong Cyberport Management Company Limited

2019 Rezoning Scheme (at 61mPD)

Notional Scheme (at 65mPD)

Project 項目

Proposed Cyberport Expansion in "OU(Cybert-Port)(1)" zone at Telegraph Bay, Pok Fu Lam, Hong Kong

– Layout Plan Submission

Visual Impact Assessment

Drawing Title 圖名

Figure 6.3
Photomontages at VP3 Footpath along Information Crescent adjacent to The Arcade Cyberport

Job No. 項目編號 Drawing No. 圖號

A/H10/95 申請編號 Application No.: _ 此頁摘自申請人提交的文件。 This page is extracted from applicant's submitted documents.


Current Scheme (at 58mPD)

ROCCO







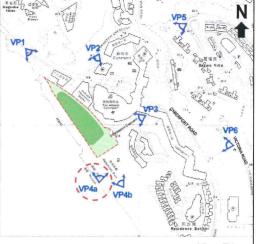

Visual Mitigation Measures:

MM1: Restricting the height of the rooftop structures at not more than 58mPD

MM2: Cascading building height

MM3: Maintaining visual permeability by providing communal garden and at-grade covered POS under high headroom

MM4: Elevated walkway from at-grade level of the Park with the landscape deck at 1/F of Proposed Development MM5: Providing landscape decks at different levels with curvy profile to mitigate the scale and soften the edge MM6: Using building materials with the appearance of lightweight and treatment with natural colors

This drawing and the contents herein are the copyright of Rocco Design Architects Limited. 本圖紙及其內容的版權屬許李嚴建築師事務有限公司所有。

No part of the drawing and the design contained herein may be reproduced without the prior written consent of a director of Rocco Design Architects Limited.

未經本公司董事書面同意,不得複製此圖紙內任何內容或設計。

Do not take measurements directly from this drawing. 切勿直接從圖紙上量度尺寸。

Check and verify all dimensions on site. 所有尺寸必須在工地現場複查及審核。

Read this drawing in conjunction with the specifications and all other related drawings. 此圖紙必須與規格說明書及其它有關圖紙一併閱讀。

Notify the Architect immediately of any discrepancy found herein 如發現內容有任何謬誤之處,應立刻通知建築師。

Client 業主

Hong Kong Cyberport Management Company Limited

2019 Rezoning Scheme (at 61mPD)

Notional Scheme (at 65mPD)

Project 項目

Proposed Cyberport Expansion in "OU(Cybert-Port)(1)" zone at Telegraph Bay, Pok Fu Lam, Hong Kong – Layout Plan Submission

Visual Impact Assessment

Drawing Title 圖名

Figure 6.4a


Photomontages at VP4a -Cyberport Waterfront Park Promenade

Drawn 製圖 Scale 比例 Checked 校對 Revision 修改版

Job No.項目編號 Drawing No. 圖號


A/H10/95 申請編號 Application No.: 此頁摘自申請人提交的文件。 This page is extracted from applicant's submitted documents.

ROCCO

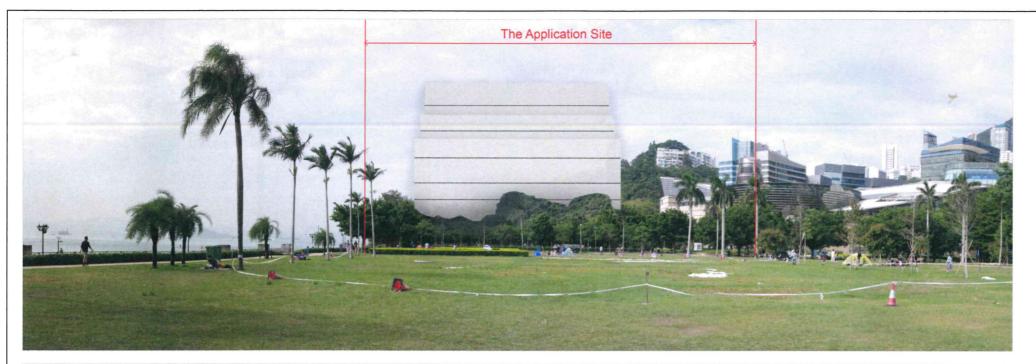





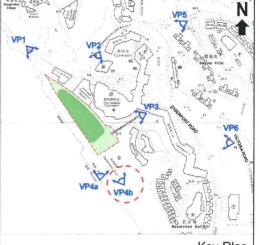

Visual Mitigation Measures:

MM1: Restricting the height of the rooftop structures at not more than 58mPD

MM2: Cascading building height

MM3: Maintaining visual permeability by providing communal garden and at-grade covered POS under high headroom

MM4: Elevated walkway from at-grade level of the Park with the landscape deck at 1/F of Proposed Development MM5: Providing landscape decks at different levels with curvy profile to mitigate the scale and soften the edge MM6: Using building materials with the appearance of lightweight and treatment with natural colors

This drawing and the contents herein are the copyright of Rocco Design Architects Limited. 本圖紙及其內容的版權屬許李嚴建築師事務有限公司所有。

不圖成及其內在可放稱圖和一子嚴定案的事物有限公司所有。
No part of the drawing and the design contained herein may be reproduced without the prior written consent of a director of Rocco Design Architects Limited.
未經本公司董事書面同意,不得複製此圖紙內任何內容或設計。

Do not take measurements directly from this drawing. 切勿直接從圖紙上量度尺寸。

Check and verify all dimensions on site 所有尺寸必須在工地現場複查及審核。

Read this drawing in conjunction with the specifications and all other related drawings. 此圖紙必須與規格說明書及其它有關圖紙一併閱讀。

Notify the Architect immediately of any discrepancy found herein. 如發現內容有任何謬誤之處,應立刻通知建築師。

Hong Kong Cyberport Management Company Limited

2019 Rezoning Scheme (at 61mPD)

Notional Scheme (at 65mPD)

Project 項目

Proposed Cyberport Expansion in "OU(Cybert-Port)(1)" zone at Telegraph Bay, Pok Fu Lam, Hong Kong – Layout Plan Submission

Visual Impact Assessment

Drawing Title 圖名

Figure 6.4b Photomontages at VP4b -Cyberport Waterfront Park


Drawn 製圖 Scale 比例 Checked 校對

Job No.項目編號 Drawing No.圖號


A/H10/95 申請編號 Application No.: 此頁摘自申請人提交的文件。 This page is extracted from applicant's submitted documents.

ROCCO

Revision 修改版

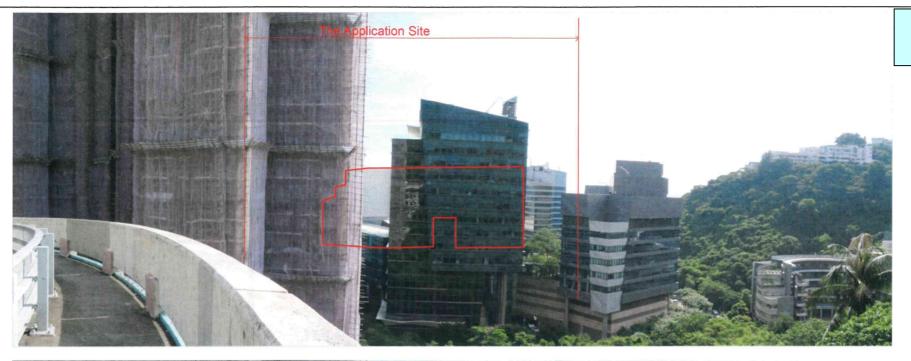




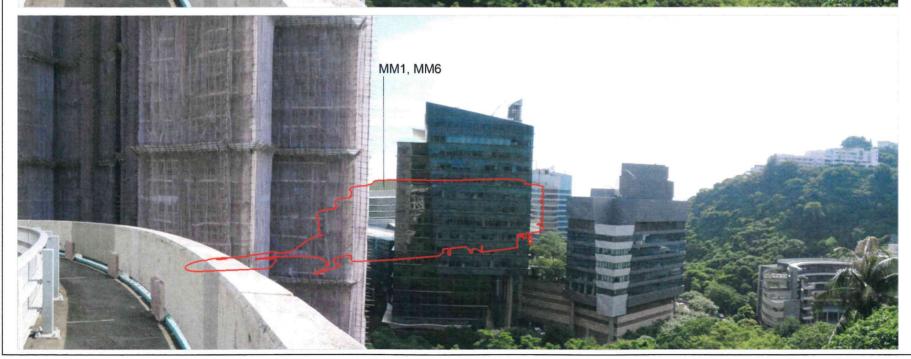

A/H10/95 申請編號 Application No.: 此頁摘自申請人提交的文件。

This page is extracted from applicant's submitted documents.

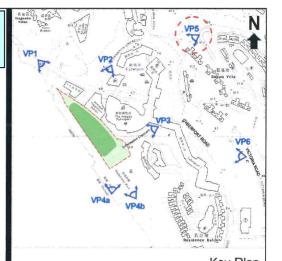

Visual Mitigation Measures:

MM1: Restricting the height of the rooftop structures at not more than 58mPD

MM2: Cascading building height

MM3: Maintaining visual permeability by providing communal garden and at-grade covered POS under high headroom

MM4: Elevated walkway from at-grade level of the Park with the landscape deck at 1/F of Proposed Development MM5: Providing landscape decks at different levels with curvy profile to mitigate the scale and soften the edge MM6: Using building materials with the appearance of lightweight and treatment with natural colors

This drawing and the contents herein are the copyright of Rocco Design Architects Limited. 本圖紙及其內容的版權屬許李嚴建築師事務有限公司所有。

No part of the drawing and the design contained herein may be reproduced without the prior written consent of a director of Rocco Design Architects Limited.
未經本公司董事書面同意,不得複製此圖紙內任何內容或設計。

Do not take measurements directly from this drawing. 切勿直接從圖紙上量度尺寸。

Check and verify all dimensions on site. 所有尺寸必須在工地現場複查及審核。

Read this drawing in conjunction with the specifications and all other related drawings. 此圖紙必須與規格說明書及其它有關圖紙一併閱讀。

Notify the Architect immediately of any discrepancy found herein. 如發現內容有任何謬誤之處,應立刻通知建築師。

Hong Kong Cyberport Management Company Limited

2019 Rezoning Scheme (at 61mPD)

Notional Scheme (at 65mPD)

Project 項目

Proposed Cyberport Expansion in "OU(Cybert-Port)(1)" zone at Telegraph Bay, Pok Fu Lam, Hong Kong – Layout Plan Submission

Visual Impact Assessment

Drawing Title 圖名

Figure 6.5

Photomontages at VP5 -Footpath along Elevated Road leading to Baguio Villa, branching off Victoria Road

Scale 比例 Drawn 製圖 Checked 校對 N/A

Job No. 項目編號 Drawing No. 圖號 Revision 修改版

ROCCO



申請編號 Application No.: _ 此頁摘自申請人提交的文件。 This page is extracted from applicant's submitted documents.

A/H10/95



Visual Mitigation Measures:

MM1: Restricting the height of the rooftop structures at not more than 58mPD

MM2: Cascading building height

MM3: Maintaining visual permeability by providing communal garden and at-grade covered POS under high headroom

MM4: Elevated walkway from at-grade level of the Park with the landscape deck at 1/F of Proposed Development MM5: Providing landscape decks at different levels with curvy profile to mitigate the scale and soften the edge MM6: Using building materials with the appearance of lightweight and treatment with natural colors

This drawing and the contents herein are the copyright of Rocco Design Architects Limited. 本圖紙及其內容的版權屬許李嚴建築師事務有限公司所有。

No part of the drawing and the design contained herein may be reproduced without the prior written consent of a director of Rocco Design Architects Limited.

未經本公司董事書面同意,不得複製此圖紙內任何內容或設計。

Do not take measurements directly from this drawing. 切勿直接從圖紙上量度尺寸。

Check and verify all dimensions on site. 所有尺寸必須在工地現場複查及審核。

Read this drawing in conjunction with the specifications and all other related drawings. 此圖紙必須與規格說明書及其它有關圖紙一併閱讀。

Notify the Architect immediately of any discrepancy found herein. 如發現內容有任何謬誤之處,應立刻通知建築師。

Hong Kong Cyberport Management Company Limited

2019 Rezoning Scheme (at 61mPD)

Notional Scheme (at 65mPD)

Project 項目

Proposed Cyberport Expansion in "OU(Cybert-Port)(1)" zone at Telegraph Bay, Pok Fu Lam, Hong Kong – Layout Plan Submission

Visual Impact Assessment


Drawing Title 圖名

Figure 6.6 Photomontages at VP6 – Victoria Road Sitting-out Area


Drawn 製圖 Scale 比例 Checked 校對

Job No. 項目編號 Drawing No. 圖號 Revision 修改版

ROCCO

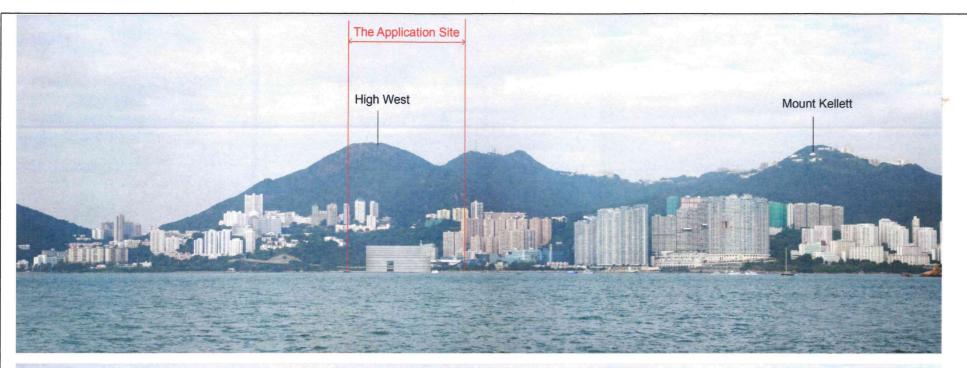



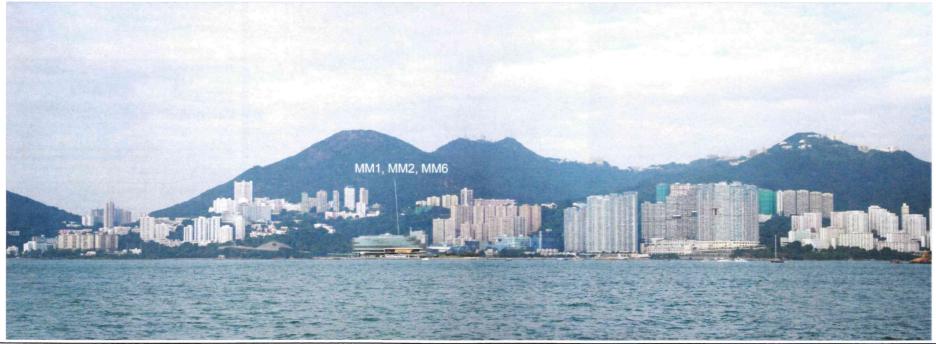



Key Plan

Visual Mitigation Measures:

MM1: Restricting the height of the rooftop structures at not more than 58mPD

MM2: Cascading building height

MM3: Maintaining visual permeability by providing communal garden and at-grade covered POS under high headroom

MM4: Elevated walkway from at-grade level of the Park with the landscape deck at 1/F of Proposed Development MM5: Providing landscape decks at different levels with curvy profile to mitigate the scale and soften the edge MM6: Using building materials with the appearance of lightweight and treatment with natural colors

This drawing and the contents herein are the copyright of Rocco Design Architects Limited. 本圖紙及其內容的版權屬許李嚴建築師事務有限公司所有。

不圖成及於1960的版傳播和子嚴定案的學物有限公司的何。
No part of the drawing and the design contained herein may be reproduced without the prior written consent of a director of Rocco Design Architects Limited.
未經本公司董事書面同意,不得複製此圖紙內任何內容或設計。

Do not take measurements directly from this drawing. 切勿直接從圖紙上量度尺寸。

Check and verify all dimensions on site. 所有尺寸必須在工地現場複查及審核。

Read this drawing in conjunction with the specifications and all other related drawings. 此圖紙必須與規格說明書及其它有關圖紙一併閱讀。

Notify the Architect immediately of any discrepancy found herein 如發現內容有任何謬誤之處,應立刻通知建築師。

Hong Kong Cyberport Management Company Limited

2019 Rezoning Scheme (at 61mPD)

Notional Scheme (at 65mPD)

Project 項目

Proposed Cyberport Expansion in "OU(Cybert-Port)(1)" zone at Telegraph Bay, Pok Fu Lam, Hong Kong – Layout Plan Submission

Visual Impact Assessment

Drawing Title 圖名

Figure 6.7

Photomontages at VP7 -Pak Kok Tsuen Pier, Lamma Island

Scale 比例 Drawn 製圖

N/A


Job No. 項目編號 Drawing No. 圖號

Revision 修改版


Checked 校對

A/H10/95 申請編號 Application No.: _ 此頁摘自申請人提交的文件 This page is extracted from applicant's submitted documents.



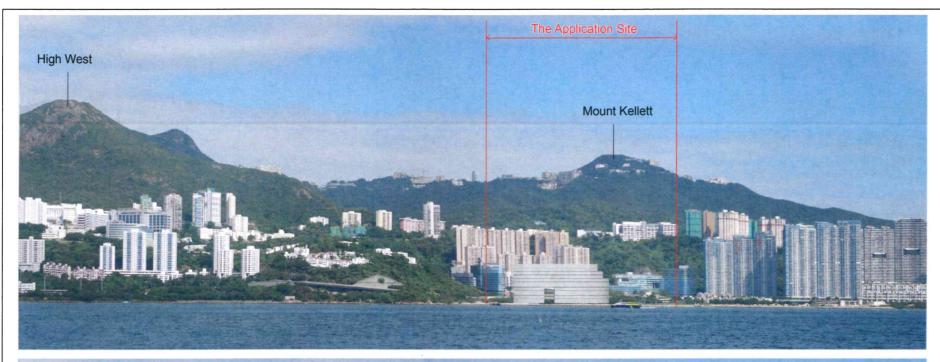



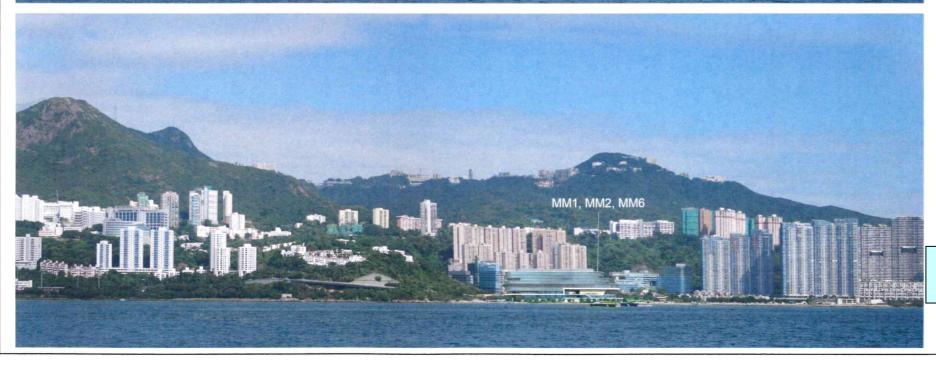



Key Plan

Visual Mitigation Measures:

MM1: Restricting the height of the rooftop structures at not more than 58mPD

MM2: Cascading building height

MM3: Maintaining visual permeability by providing communal garden and at-grade covered POS under high headroom

MM4: Elevated walkway from at-grade level of the Park with the landscape deck at 1/F of Proposed Development

MM5: Providing landscape decks at different levels MM5: Providing landscape decks at different levels with curvy profile to mitigate the scale and soften the edge MM6: Using building materials with the appearance of lightweight and treatment with natural colors

This drawing and the contents herein are the copyright of Rocco Design Architects Limited. 本圖紙及其內容的版權屬許李嚴建築師事務有限公司所有。

No part of the drawing and the design contained herein may be

reproduced without the prior written consent of a director of Rocco Design Architects Limited. 未經本公司董事書面同意,不得複製此圖紙內任何內容或設計。 Do not take measurements directly from this drawing. 切勿直接從圖紙上量度尺寸。

Check and verify all dimensions on site. 所有尺寸必須在工地現場複查及審核。

Read this drawing in conjunction with the specifications and all other related drawings. 此圖紙必須與規格說明書及其它有關圖紙一併閱讀。

Notify the Architect immediately of any discrepancy found herein. 如發現內容有任何謬誤之處,應立刻通知建築師。

Client 業主

Hong Kong Cyberport Management Company Limited

2019 Rezoning Scheme (at 61mPD)

Notional Scheme (at 65mPD)

Project 項目

Proposed Cyberport Expansion in "OU(Cybert-Port)(1)" zone at Telegraph Bay, Pok Fu Lam, Hong Kong – Layout Plan Submission

Visual Impact Assessment

Drawing Title 圖名

Figure 6.8 Photomontages at VP8 –
Public Ferry Route between Central and

Lamma Island (Yung Shue Wan)


Scale 比例 Drawn 製圖 Checked 校對


Job No. 項目編號 Drawing No. 圖號


Revision 修改版


A/H10/95 申請編號 Application No.: 此頁摘自申請人提交的文件。 This page is extracted from applicant's submitted documents.

ROCCO

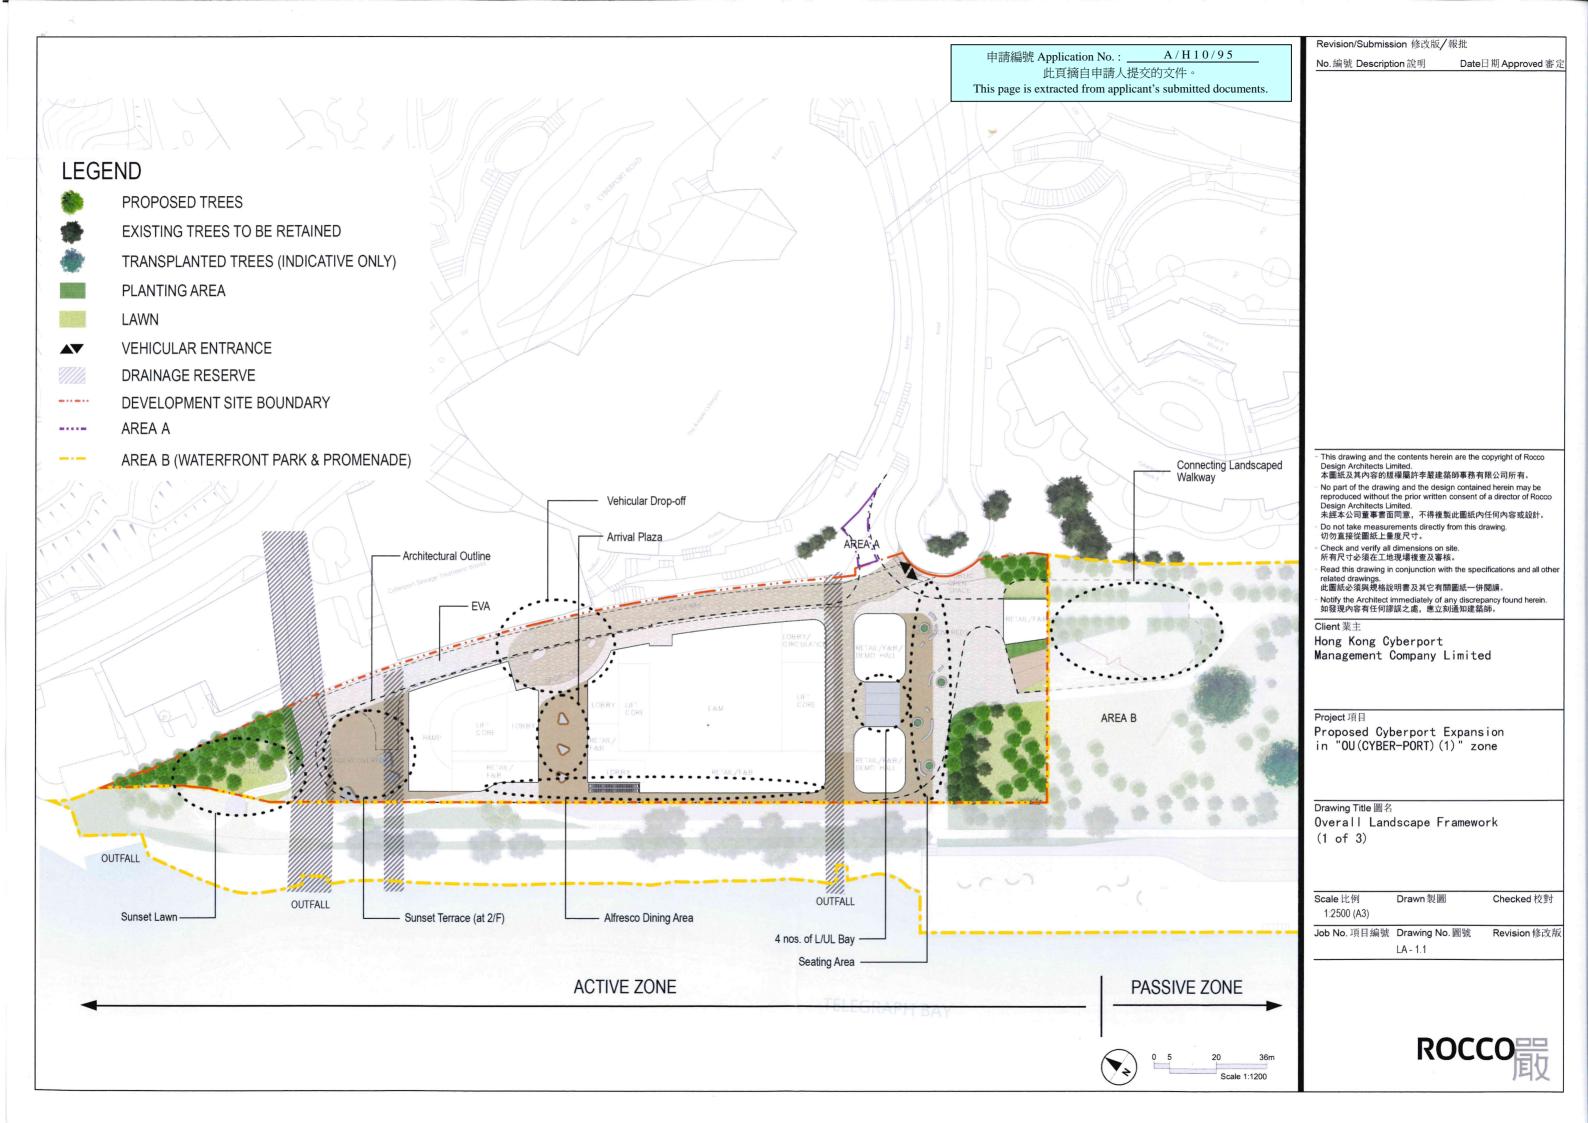

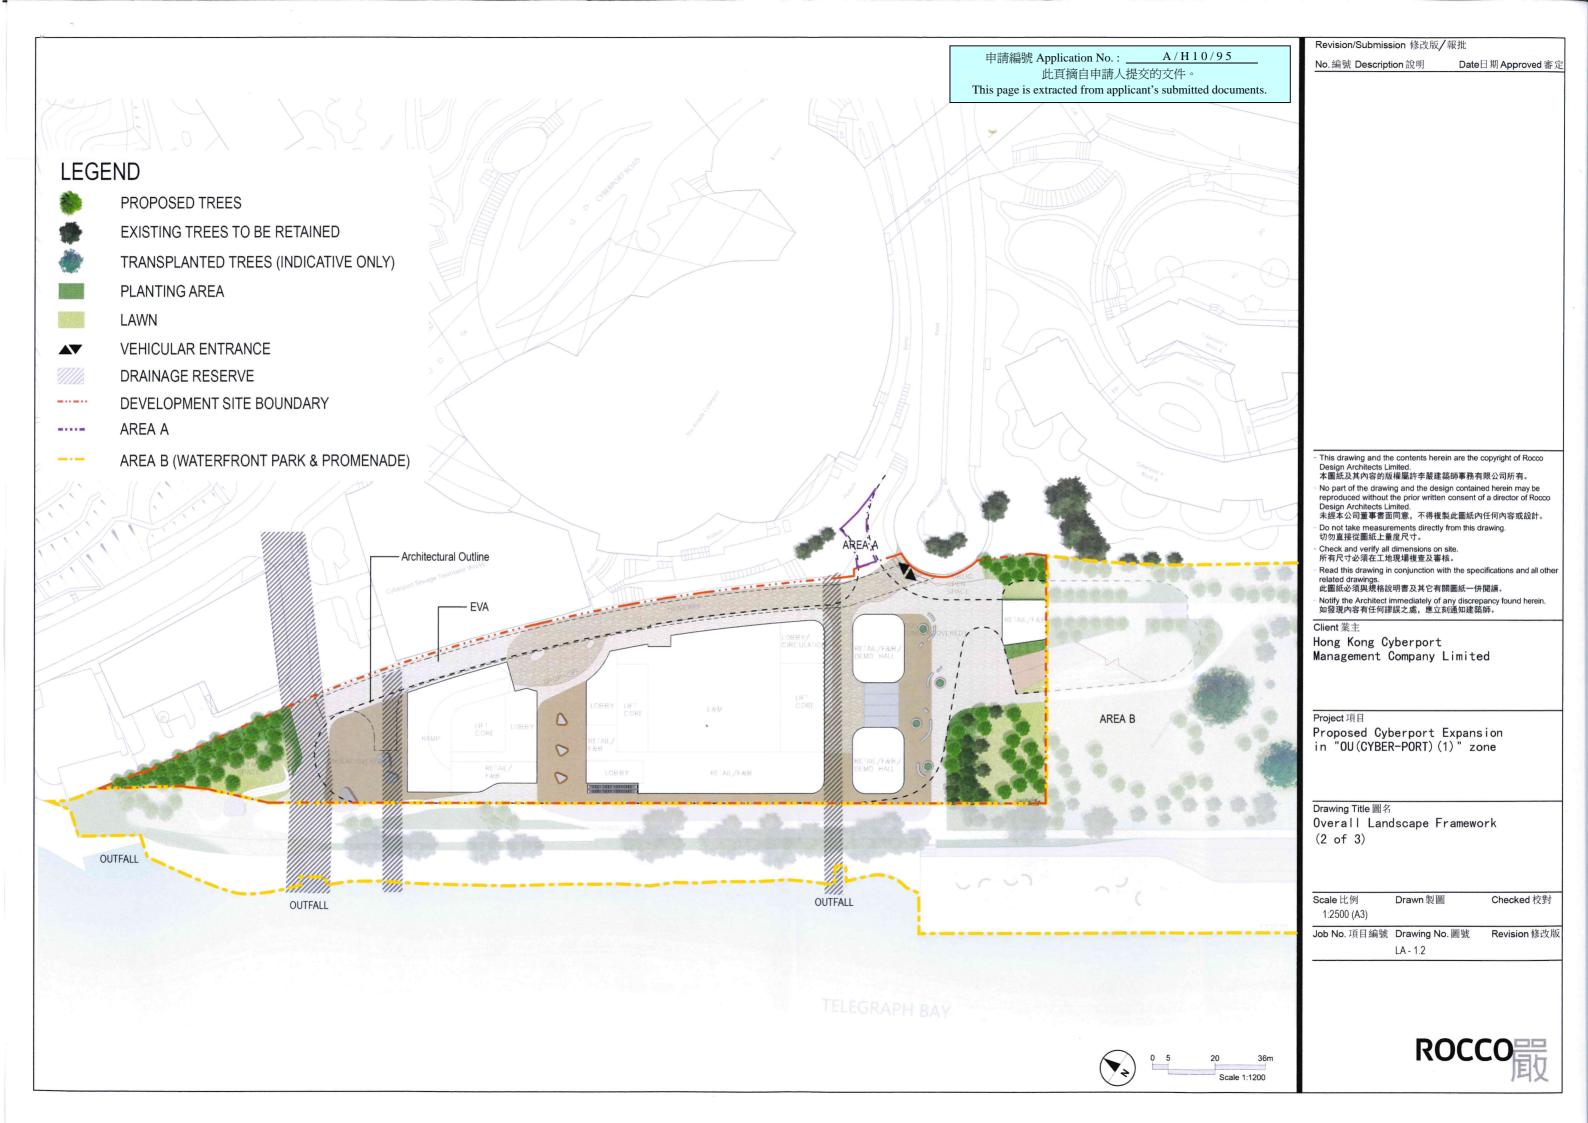

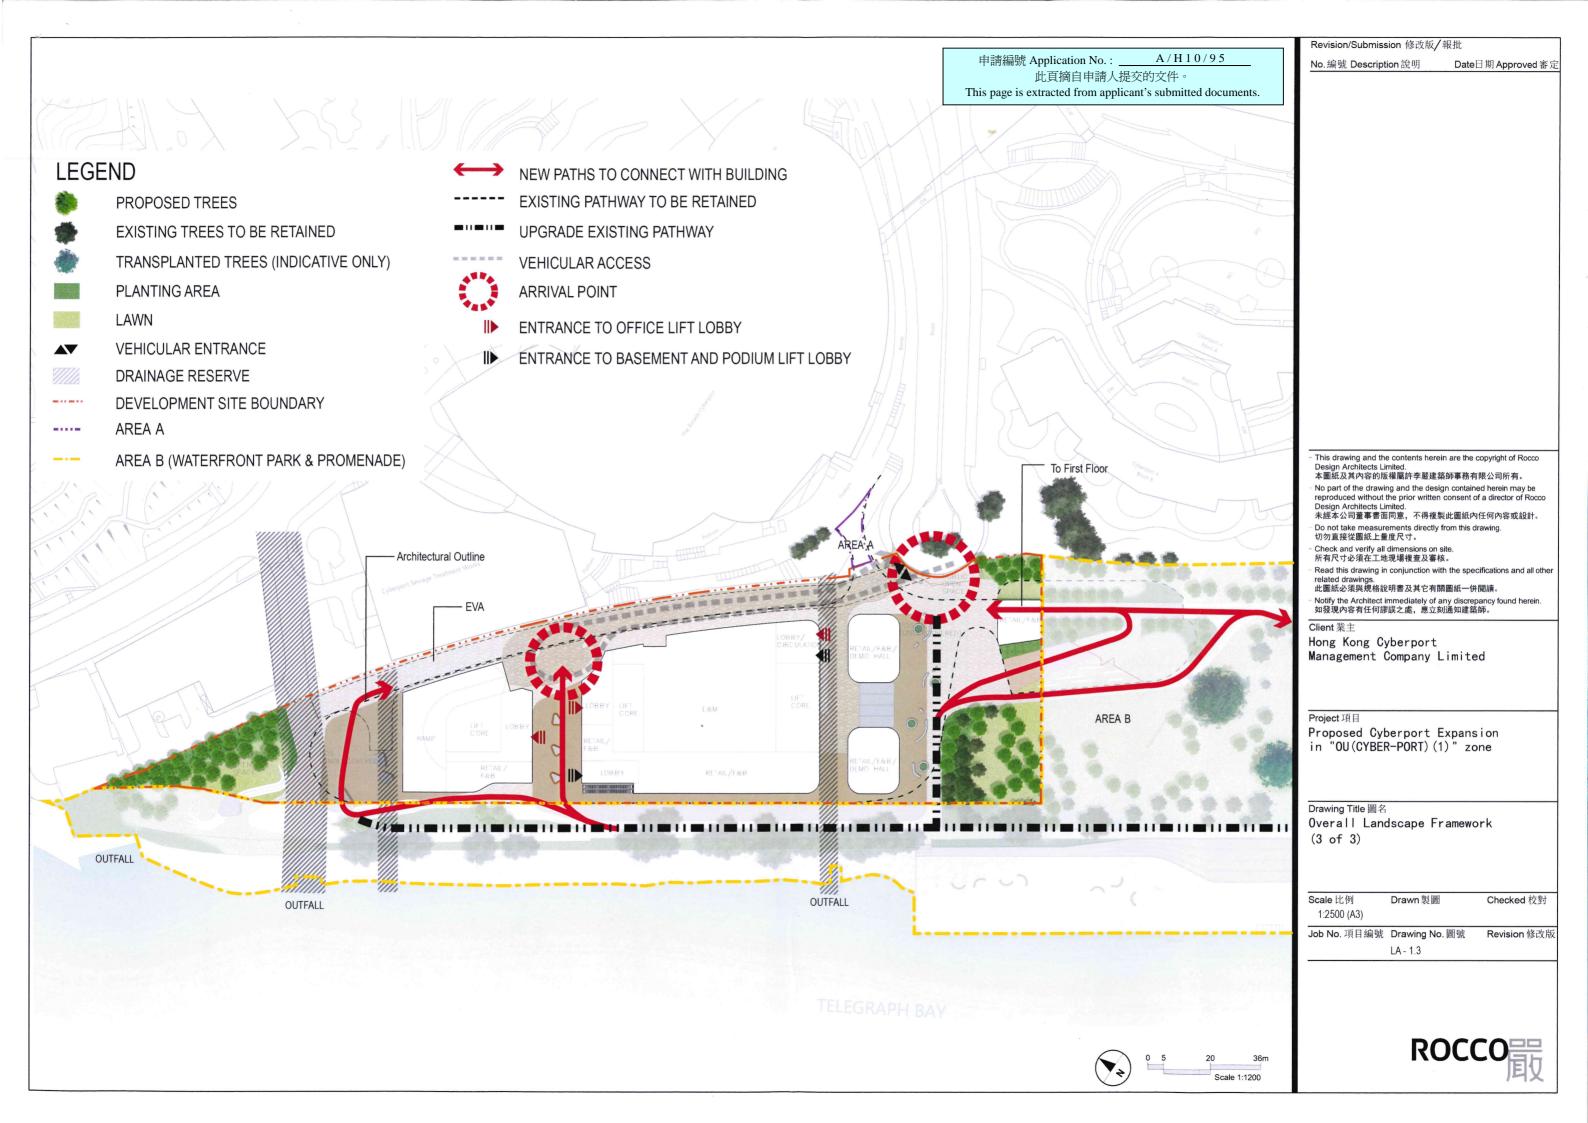

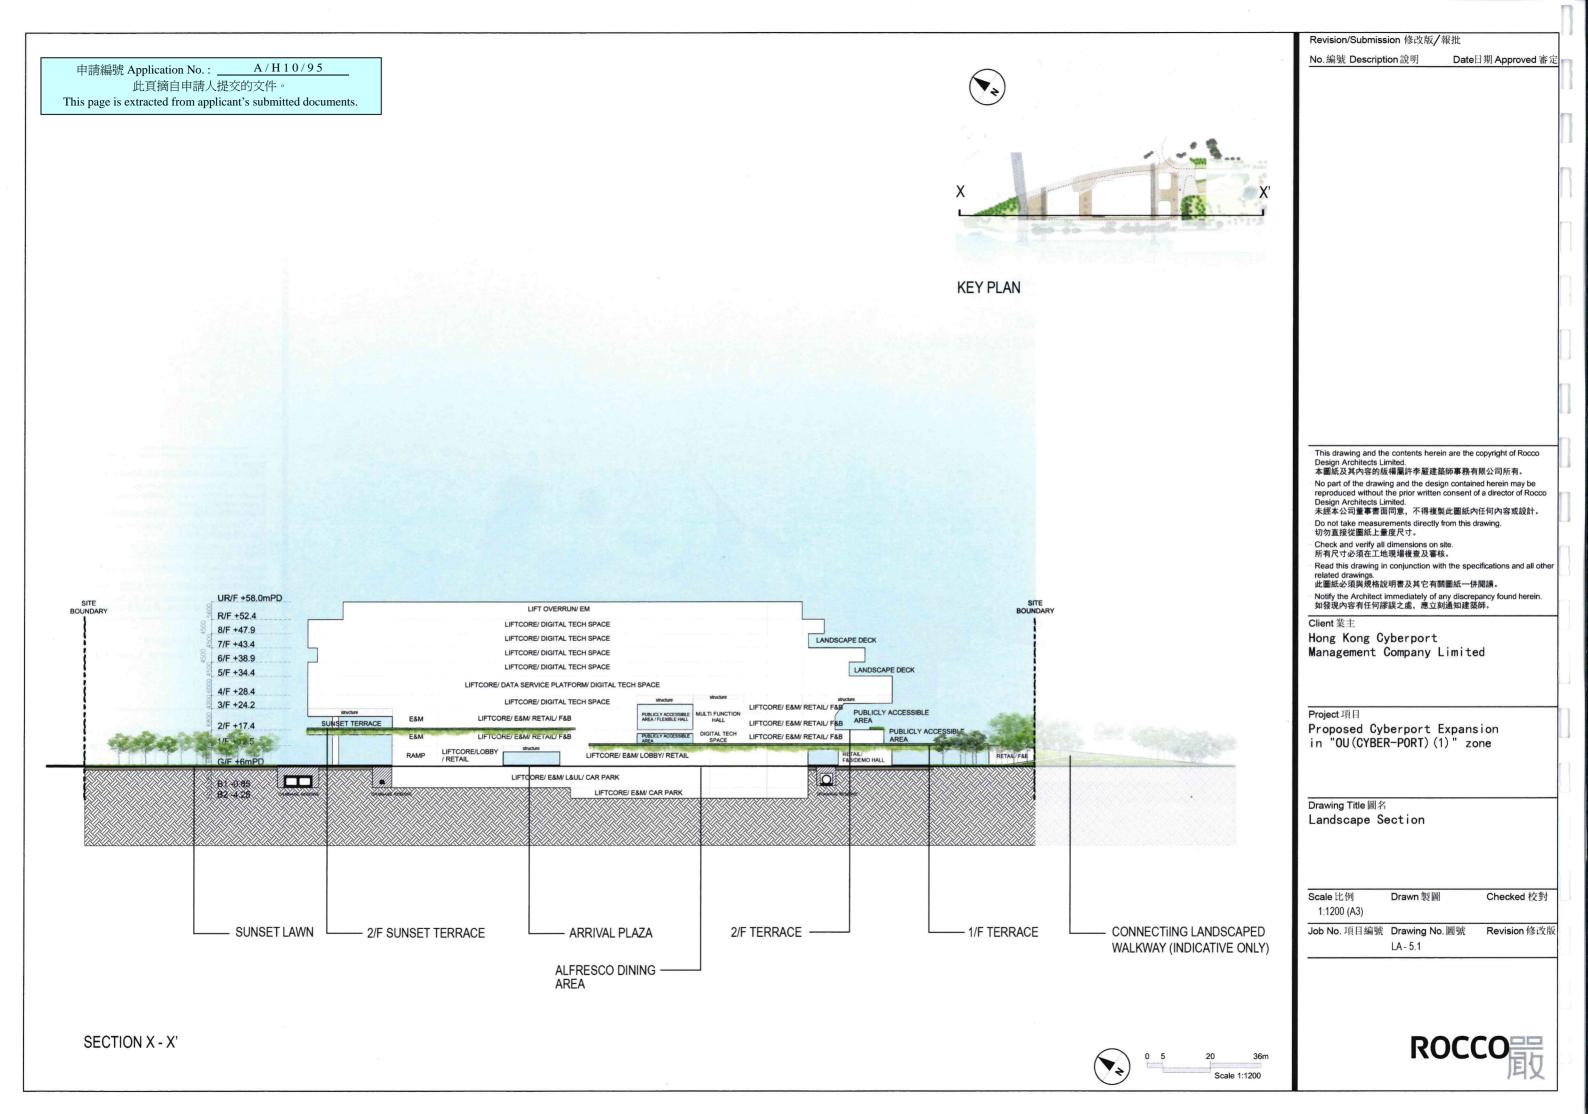

申請編號 Application No.: A/H10/95

與申請地點/處所有關的先前申請 Previous Applications Covering the Application Site/Premises

申請編號	擬議用途/發展	城市規劃委員會的決定(日期)			
Application No.	Proposed Use/Development	Decision of			
		Town Planning Board (Date)			
Nil 沒有					

有關資料是為方便市民大眾參考而提供。對於所載資料在使用上的問題及文義上的歧異,城市規劃委員會慨不負責。若有任何疑問,應查閱申請人提交的文件。

The information is provided for easy reference of the general public. Under no circumstances will the Town Planning Board accept any liabilities for the use of the information nor any inaccuracies or discrepancies of the information provided. In case of doubt, reference should always be made to the submission of the applicant.