

F.S. NOTES

- UNLESS OTHERWISE SPECIFIED, ALL DIMENSIONS SHALL BE IN MM.
- ACCORDING TO CODES OF PRACTICE FOR MINIMUM FIRE SERVICE INSTALLATIONS AND EQUIPMENT 2012, CLAUSE 5.11 & 5.14, MFA SYSTEM & FIRE HOSE REEL SYSTEM SHALL BE PROVIDED.
- 2000 LITRE EFFECTIVE STORAGE CAPACITY GRP F.S. WATER TANK SHALL BE PROVIDED AT G/F FOR THE HOSE REEL SYSTEM.
- PRIMARY & SECONDARY ELECTRICAL POWER SUPPLY SHALL BE PROVIDED FOR ALL F.S. INSTALLATION.
- IN ACCORDANCE WITH PARA. 5.9 OF THE CODE OF PRACTICE FOR MINIMUM FIRE SERVICE INSTALLATIONS AND EQUIPMENT 2012, EMERGENCY LIGHT SHALL BE PROVIDED.

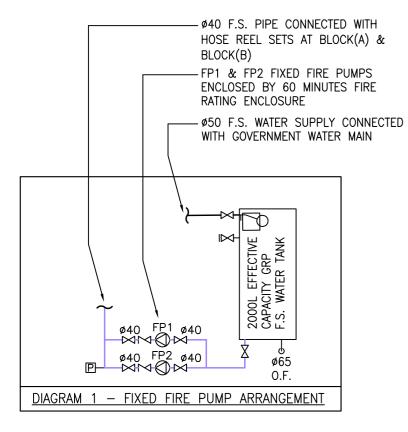

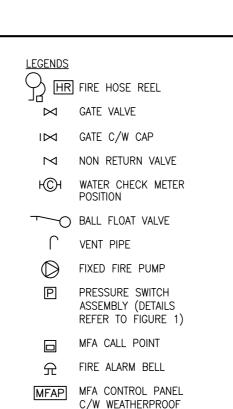

TYPE CABINET

CONTROL PANEL C/W WEATHERPROOF

DETAILS FIXED FIRE


PUMPS & F.S. TANK

FFPP FIRE FIRE PUMP

DWAR

ENCLOSURE

INSTALLATION ARRANGEMENT

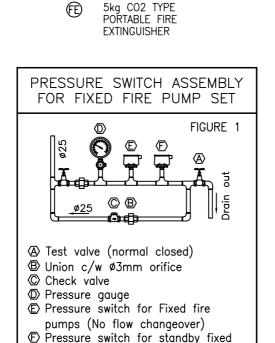

fire pump no flow signal

FSI Contractor:

ARRREVIATIONS

MFA

EX.

BL

AUTO

C/W

МН

VΡ

OF

CL

<u>ARRKE</u>	MATIONS	
F/A	FROM ABOVE	
F/B	FROM BELOW	BUILDING BLOCK PLAN (SCALE: N.T.S.)
T/A	TO ABOVE	V /
T/B	TO BELOW	-11.9
L/L	LOW LEVEL	S/TM-LTYY/9
M/L	MIDDLE LEVEL	GEE Vecent D.D. 130
H/L	HIGH LEVEL	11.8
AFFL	ABOVE FINISH FLOOR LEVEL	1568 Storage got 5.8 m 3.8 8 Agents The Parking of
F.S.	FIRE SERVICES	Angula CR 3 SF Wooden
HR	FIRE HOSE REEL	804 S.B 98.5
FH	FIRE HYDRANT	AMBILL ASCUL
FSI	FIRE SERVICES INLET	CIR Contain Final Estate Agent SCASE RP RES

MANUAL FIRE ALARM

BOUNDARY LINE

COMPLETE WITH

OVERFLOW PIPE

ACCESS MANHOLE

EXISTING

AUTOMATIC

VENT PIPE

CAT LADDER

COR A CONTROL PROMITE CONTROL OF SCALS B RP RES STORES STO
APPLICATION SITE FOR TEMPORARY SHOP AND SERVICES FOR A PERIOD OF 5 YEARS LOTS 804 S.B RP (PART), 804 S.B ss.3S.B, 804 S.B ss.3RF (PART) AND 804 S.B ss.6 IN D.D. 130, 83 LAM TEI MAIN STREET, LAM TEI, TUEN MUN, N.T.

機管花園

SCHEDULE OF THE BUILDINGS								
BLOCK	HIGHEST HEIGHT	UNIT	STORAGE	USAGE	GROSS AREA	TOTAL GROSS AREA	COVERAGE AREA c/w CANOPY	
(A)	5m	(1)	ı	SHOP	20 m²	140 m²	95 m²	
		(2)	2	SHOP	Lower: 70 m²			
					Upper: 50 m²			
(B)	5m	(3)	1	SHOP	25 m²	145 m²	148 m²	
		(4)	1	SHOP	120 m ²			

Project:

PROPOSED FIRE SERVICES INSTALLATION AT NO. 83 LAM TEI MAIN STREET, TUEN MUN, NEW TERRITORIES.

Drawing Title:


NOTES, LEGENDS, ABBREVIATION, SCHEDULE OF THE BUILDINGS & BLOCK PLAN.

KEI YIP FIRE ENGINEERING LTD.

Rm 727A, Block 1, Wang Cheong Factory Estate, Cheung Sha Wan, Kln. Email: keiyipfire@gmail.com Tel: (852)2387 8772 Fax: (852) 27480011

	Scale:	Rev.	•	Description	•	Date	Proj. Ref:
	N.T.S.	Α	•	FSI DWG RESUBMISSION ACCORDING TO THE UPDATED BUILDING LAYOUT PLAN	• NO	V 2019	K230
	28 AUG 2019	В	•		• FF	B 2020	Dwg. No:
	Drawn: P.L. YAU			AS LET LOD S COMMENTS BATED S VAIL 2020			FS-01
٦.							Revision
	Checked: C.C. IO						В

N.T.S.	Rev.	•	Description				
N.1.5.	_		FSI DWG RESUBMISSION				
Date:	A	•	UPDATED BUILDING LAYO				
28 AUG 2019	R		AS PER FSD'S COMMEN				
Drawn:			ACTENTODO COMMEN				
P.L. YAU							

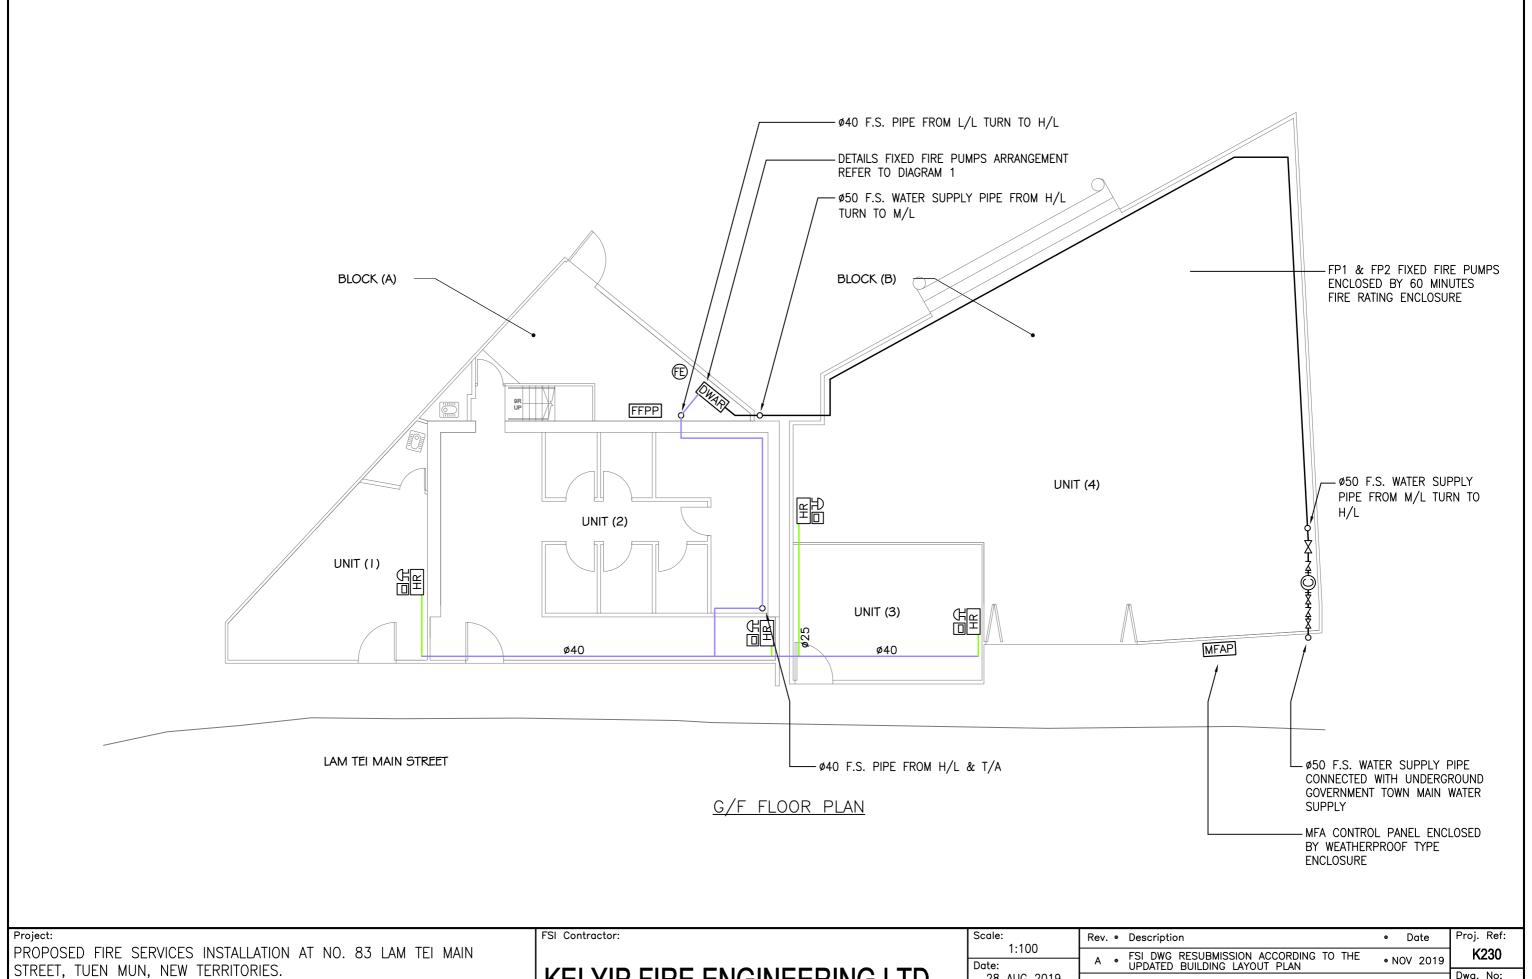


STREET, TUEN MUN, NEW TE

FIRE SERVICES INSTALLATION GROUND FLOOR PLAN

KEI YIP FIRE ENGINEERING LTD.

Rm 727A, Block 1, Wang Cheong Factory Estate, Cheung Sha Wan, Klr Email: keiyipfire@gmail.com Tel: (852)2387 8772 Fax: (852) 27480011

	Scale:	Rev.	•	Description	•	Date	Proj. Ref:
	1:100 Date:	Α	٠	FSI DWG RESUBMISSION ACCORDING TO THE UPDATED BUILDING LAYOUT PLAN	• N	OV 2019	K230
•	28 AUG 2019 Drawn:	В	•	AS PER FSD'S COMMENTS DATED 9 JAN 2020	• FI	EB 2020	Dwg. No: FS-03
Kln.	P.L. YAU Checked:						Revision R
'	C.C. LO	l					D

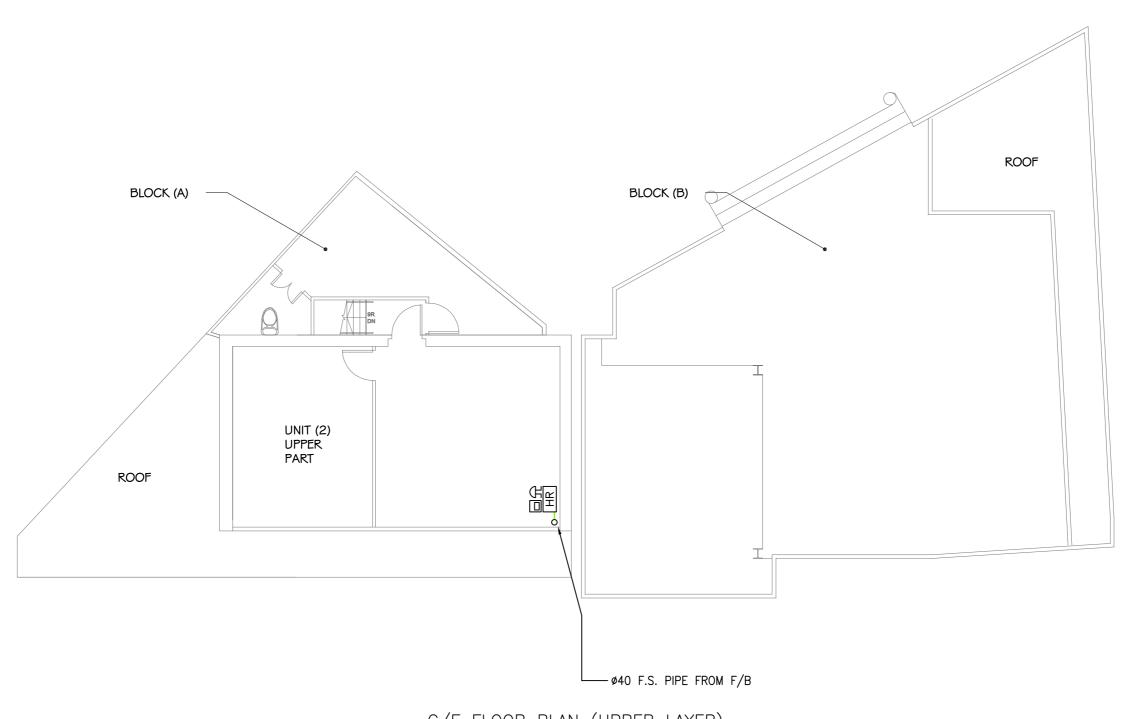

G/F FLOOR PLAN (UPPER LAYER)


PROPOSED FIRE SERVICES INSTALLATION AT NO. 83 LAM TEI MAIN STREET, TUEN MUN, NEW TERRITORIES. Drawing Title: FIRE SERVICES INSTALLATION G/F FLOOR PLAN (UPPER LAYER)

FSI Contractor:

KEI YIP FIRE ENGINEERING LTD.

Rm 727A, Block 1, Wang Cheong Factory Estate, Cheung Sha Wan, Kl Email: keiyipfire@gmail.com Tel: (852)2387 8772 Fax: (852) 27480011

	Scale:	Rev.	•	Description	•	Date	Proj. Ref:
	1:100 Date:	Α	•	FSI DWG RESUBMISSION ACCORDING TO THE UPDATED BUILDING LAYOUT PLAN	• NO	OV 2019	K230
	28 AUG 2019	В	•	AS PER FSD'S COMMENTS DATED 9 JAN 2020	• FE	B 2020	Dwg. No: FS-04
Kln.	P.L. YAU						Revision
1	Checked: C.C. LO						В

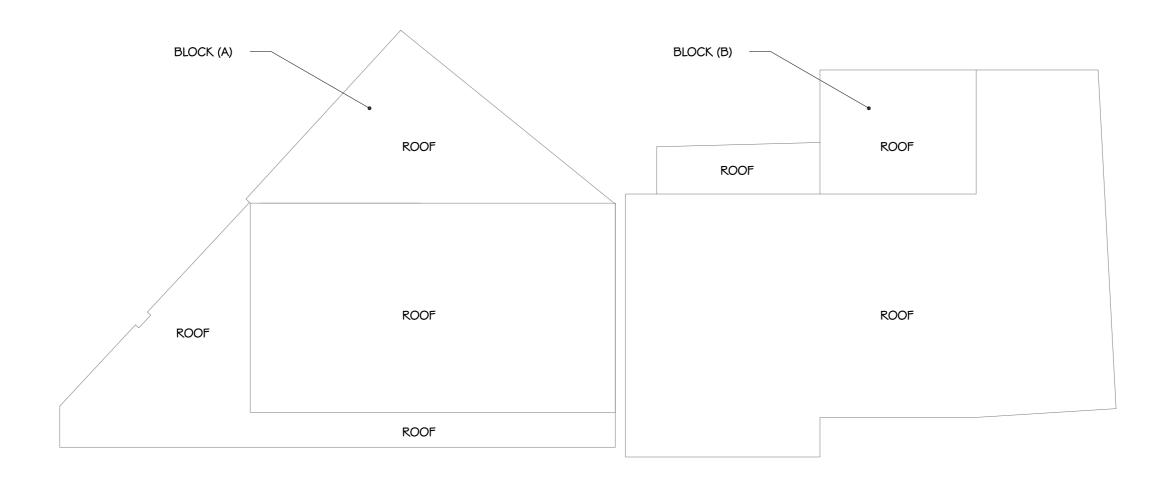


ROOF PLAN


Project:	FSI Contractor:	Scale:	Rev. • Description • Date	Proj. Ref:
PROPOSED FIRE SERVICES INSTALLATION AT NO. 83 LAM TEI MAIN		1:100 Date:	A • FSI DWG RESUBMISSION ACCORDING TO THE • NOV 2019	K230
STREET, TUEN MUN, NEW TERRITORIES. Drawing Title:	KEI YIP FIRE ENGINEERING LTD.	28 AUG 2019	B • AS PER FSD'S COMMENTS DATED 9 JAN 2020 • FEB 2020	Dwg. No: FS-05
FIRE SERVICES INSTALLATION ROOF PLAN		Drawn: P.L. YAU		Revision
THE SERVICES INSTRUCTION ROOT I BIN	Rm 727A, Block 1, Wang Cheong Factory Estate, Cheung Sha Wan, Kln. Email: keiyipfire@gmail.com Tel: (852)2387 8772 Fax: (852) 27480011	Cneckea:		B Revision
		C.C. LO		

	FIXED FIRE PUMP SCHEDULE							
PUMP CODE	DESCRIPTION	PUMP MOTOR POWER RATING (kW)	FLOW RATE (L/min)	PUMP HEAD (BAR)				
FP1	FIXED FIRE PUMP (DUTY)	2.2	48	5				
FP2	FIXED FIRE PUMP (STANDBY)	2.2	48	5				

_						
	F.S. PIPE SIZE COLOUR COPE					
Γ	PIPE SIZE	COLOUR				
	ø25	GREEN				
	ø40	PURPLE				
	ø80	DARK GREEN				

STATUS OF FIXED FIRE PUMPS	S
1. FP1 POWER SUPPLY ON 2. FP1 PUMP RUNNING 3. FP1 PUMP FAILED	4. FP2 POWER SUPPLY ON 5. FP2 PUMP RUNNING 6. FP2 PUMP FAILED

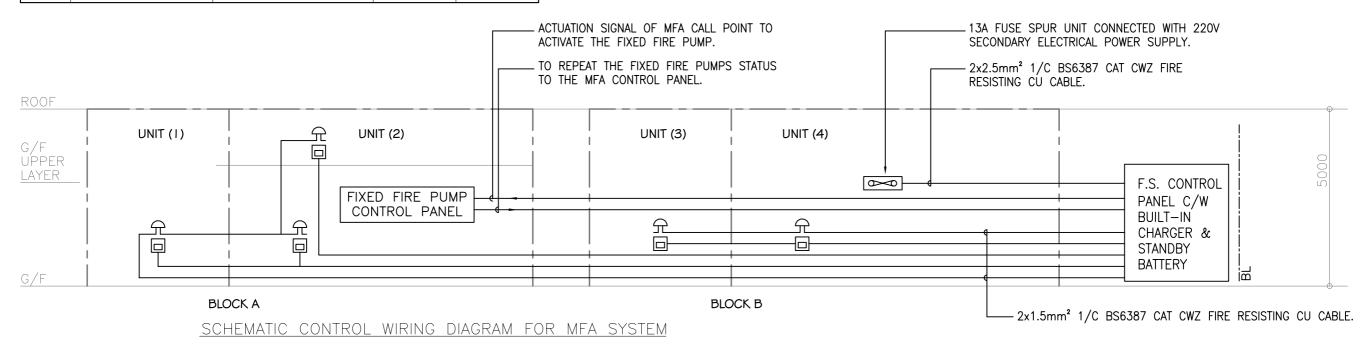

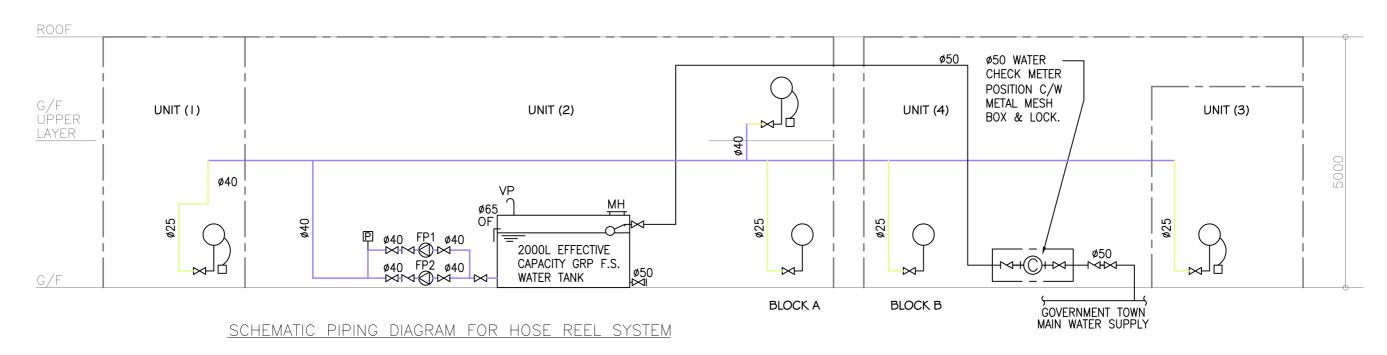

PROPOSED FIRE SERVICES INSTALLATION AT NO. 83 LAM TEI MAIN STREET, TUEN MUN, NEW TERRITORIES.

Drawing Title:
SCHEMATIC CONTROL WIRING DIAGRAM FOR MFA SYSTEM & SCHEMATIC PIPING DIAGRAM FOR HOSE REEL SYSTEM

KEI YIP FIRE ENGINEERING LTD.

FSI Contractor:

Rm 727A, Block 1, Wang Cheong Factory Estate, Cheung Sha Wan, Kln. Email: keiyipfire@gmail.com Tel: (852)2387 8772 Fax: (852) 27480011

	Scale:	Rev.	•	Description	• Date	Proj. Ref:
	1:100 Date:	Α	•	FSI DWG RESUBMISSION ACCORDING TO THE UPDATED BUILDING LAYOUT PLAN	• NOV 2019	K230
(In.	28 AUG 2019	В	•	AS PER FSD'S COMMENTS DATED 9 JAN 2020	• FFB 2020	Dwg. No:
	Drawn: P.L. YAU			THE FER THE COMMITTEE BY THE COMMITTEE COMMITT	,	FS-02
						Revision
	Checked: C.C. LO					В