
Ref.: PPC-PLG-10151

### Annex 1


Application Site on Lot Index Plan

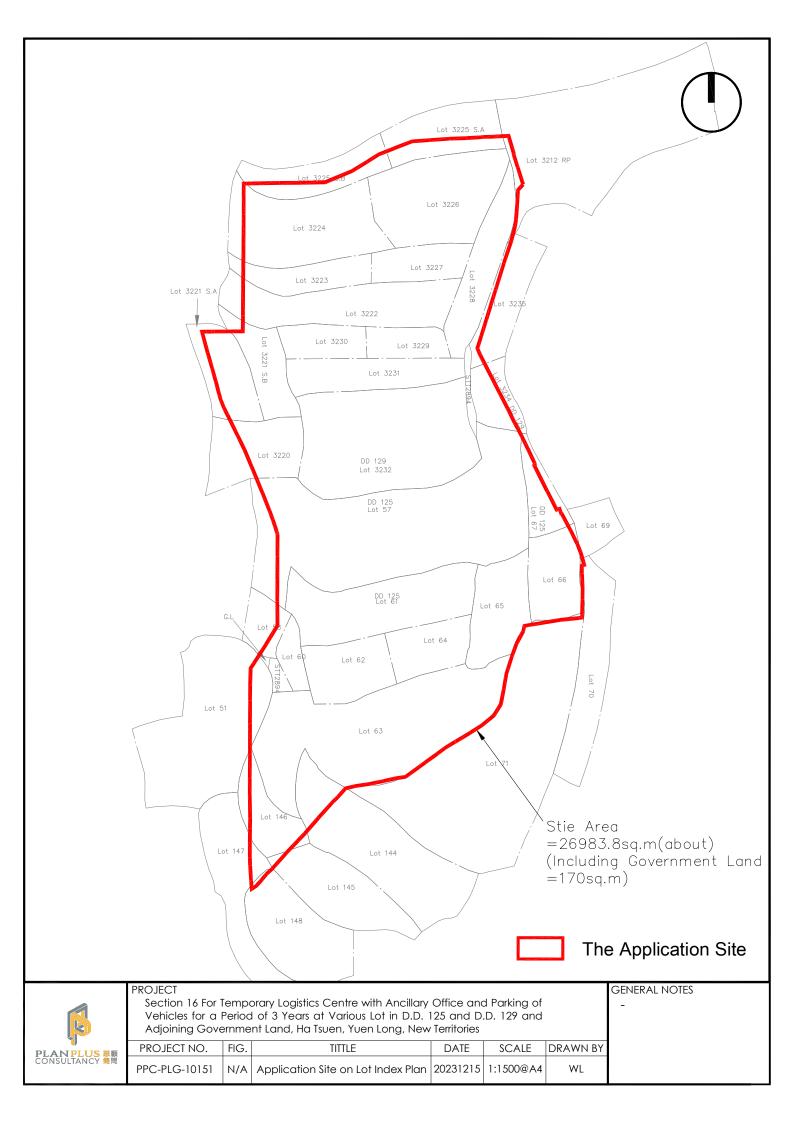

Ref.: PPC-PLG-10151

## Annex 2


Layout Plan

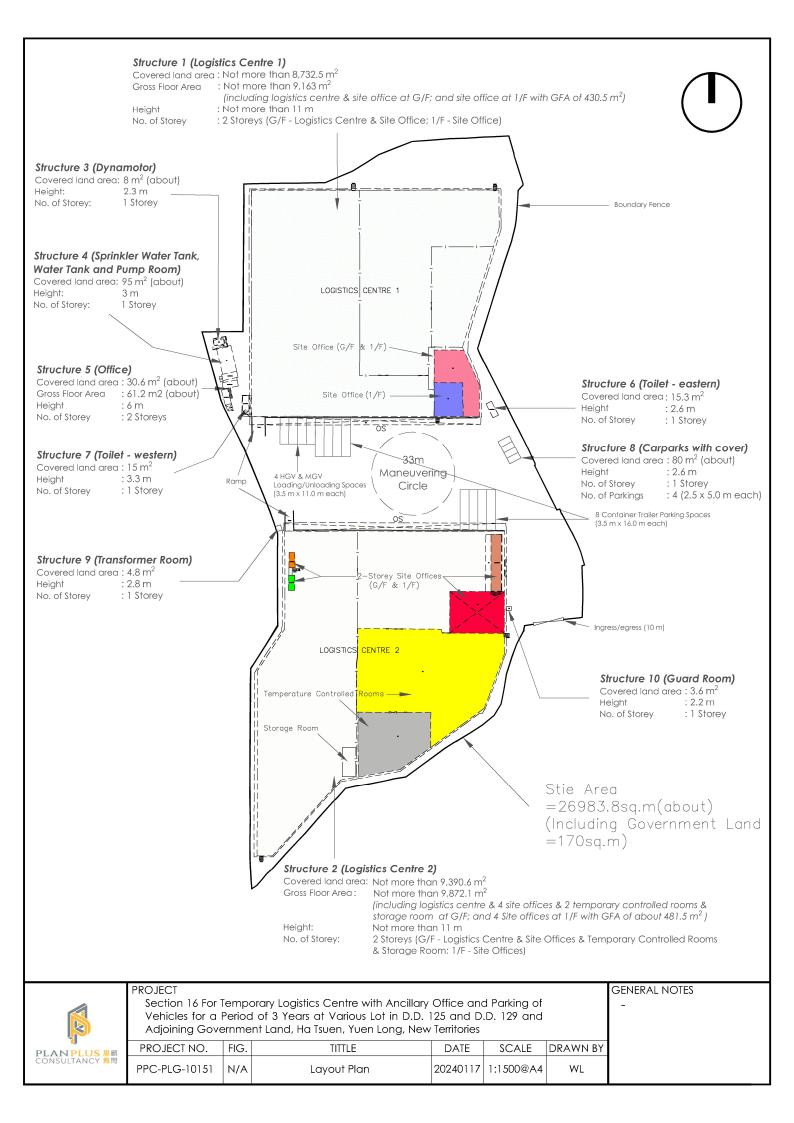

Ref.: PPC-PLG-10151

## Annex 3

Landscape Plan

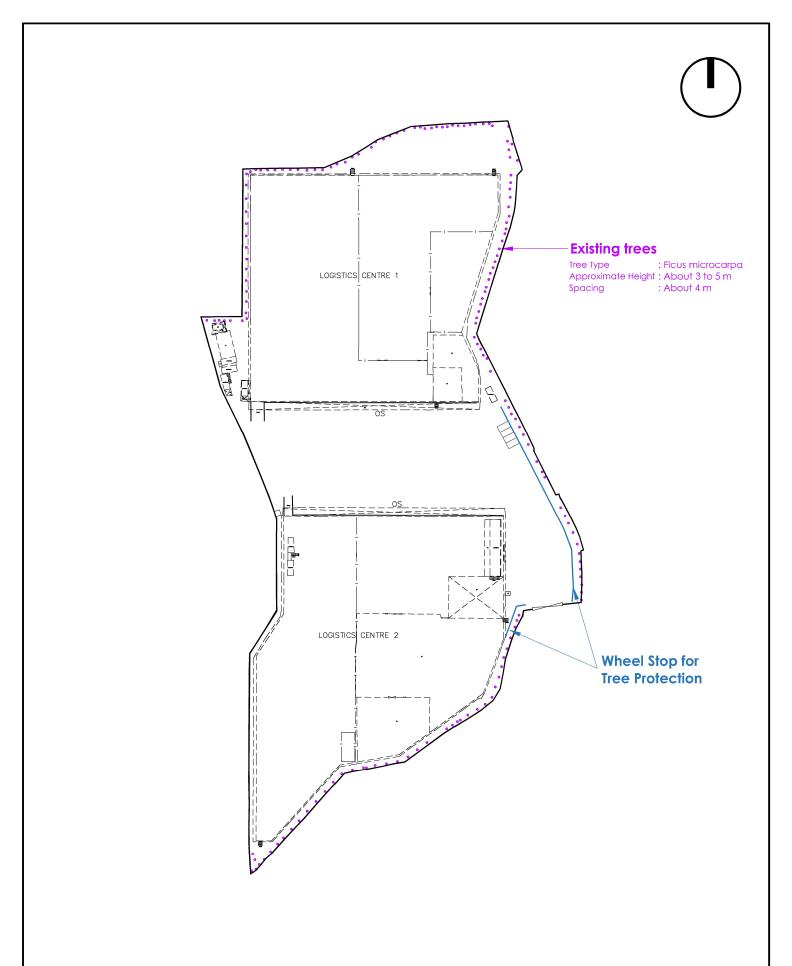



PROJECT

Section 16 For Temporary Logistics Centre with Ancillary Office and Parking of Vehicles for a Period of 3 Years at Various Lot in D.D. 125 and D.D. 129 and Adjoining Government Land, Ha Tsuen, Yuen Long, New Territories

PROJECT NO.	FIG.	TITTLE	DATE	SCALE	DRAWN BY
PPC-PLG-10151	N/A	Landscape Plan	20231215	1:1500@A4	WL


GENERAL NOTES

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Ref.: PPC-PLG-10151

### Annex 4

As-built Drainage Plan



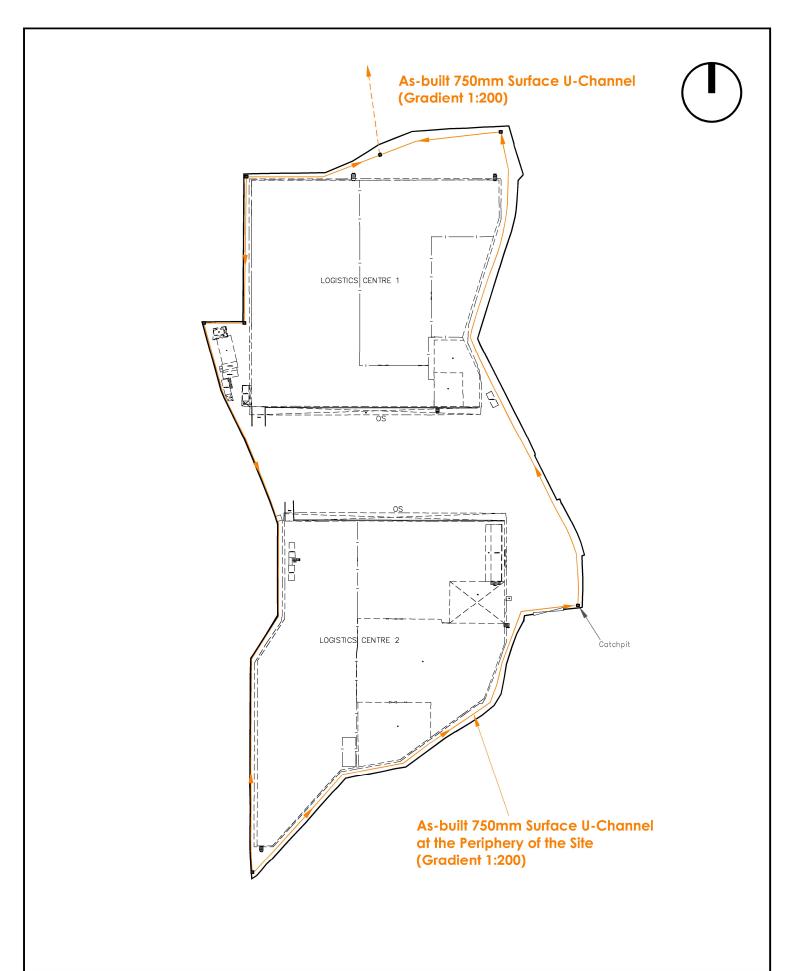

PROJECT

Section 16 For Temporary Logistics Centre with Ancillary Office and Parking of Vehicles for a Period of 3 Years at Various Lot in D.D. 125 and D.D. 129 and Adjoining Government Land, Ha Tsuen, Yuen Long, New Territories


PROJECT NO.	FIG.	TITTLE	DATE	SCALE	DRAWN BY
PPC-PLG-10151	N/A	As-built Drainage Plan	20231215	1:1500@A4	WL


GENERAL NOTES


Section 16 Planning Application for the Proposed Temporary Logistics Centre with Ancillary Office and Parking of Vehicles for a Period of 3 Years at Various Lots in D.D. 125 and D.D. 129 and Adjoining Government Land, Ha Tsuen, Yuen Long, New Territories  Planning Statement	Ref.: PPC-PLG-10151


Annex 5


Comparison Drawings with the Previously Approved Application No. A/HSK/319

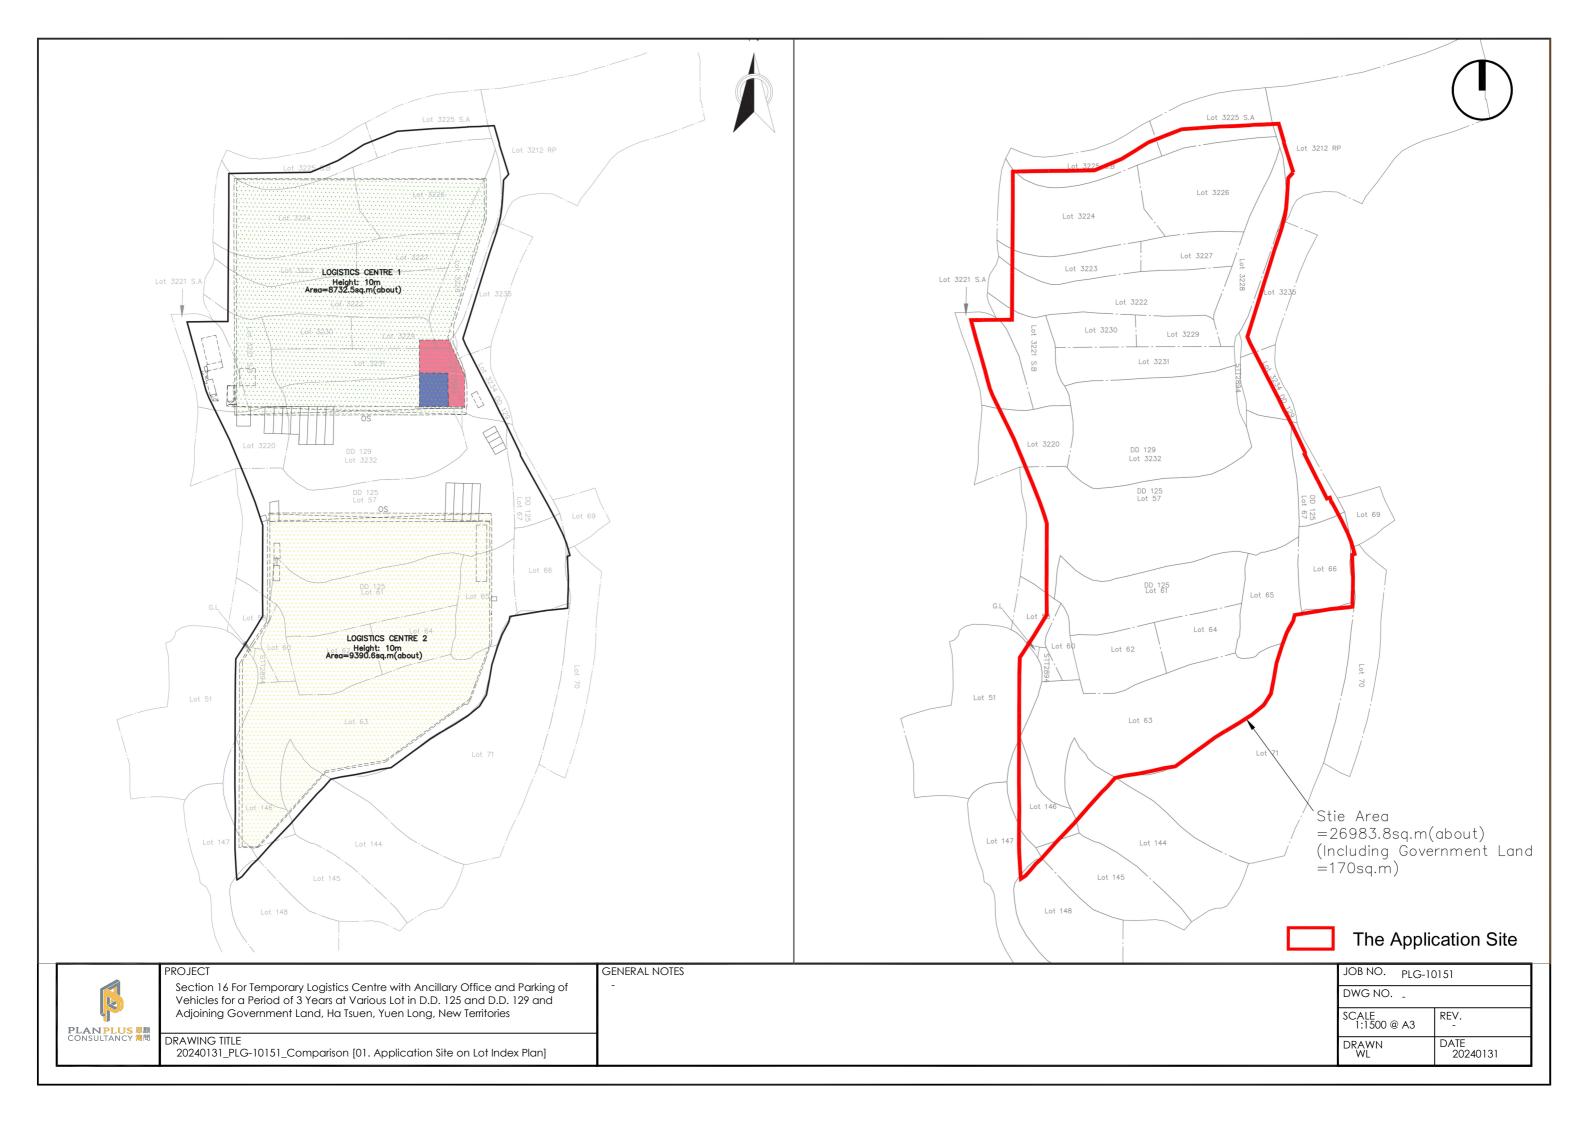

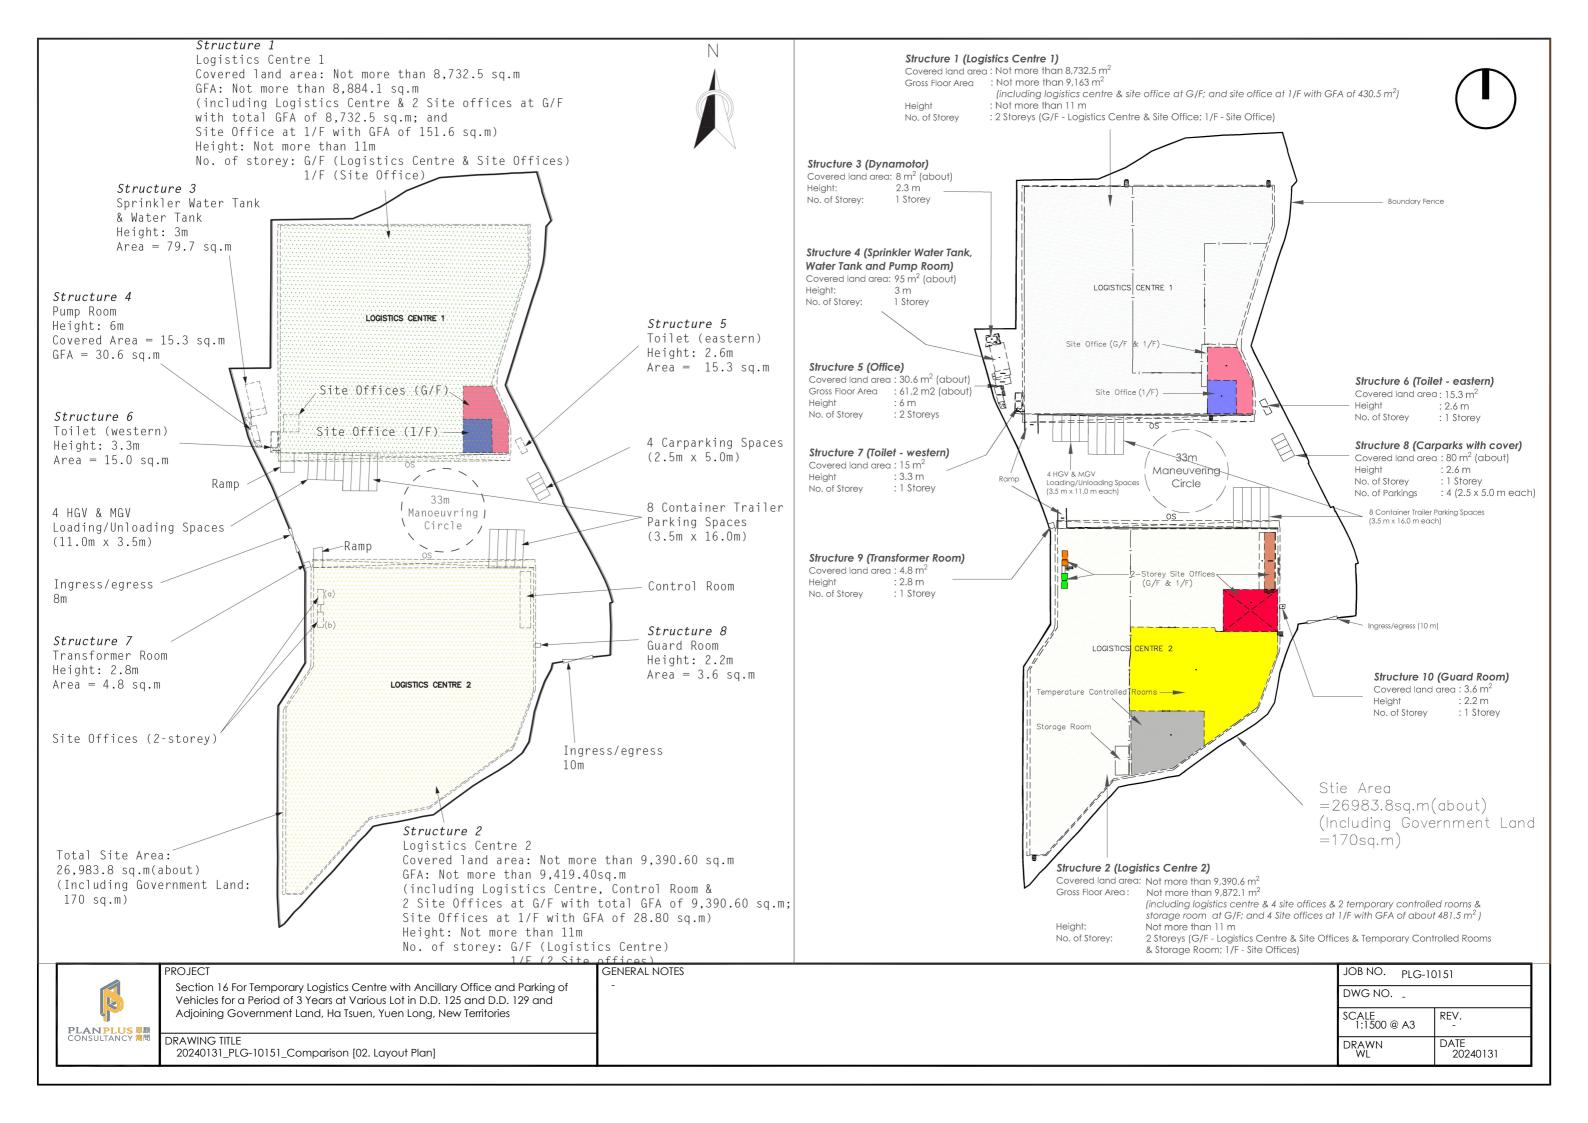

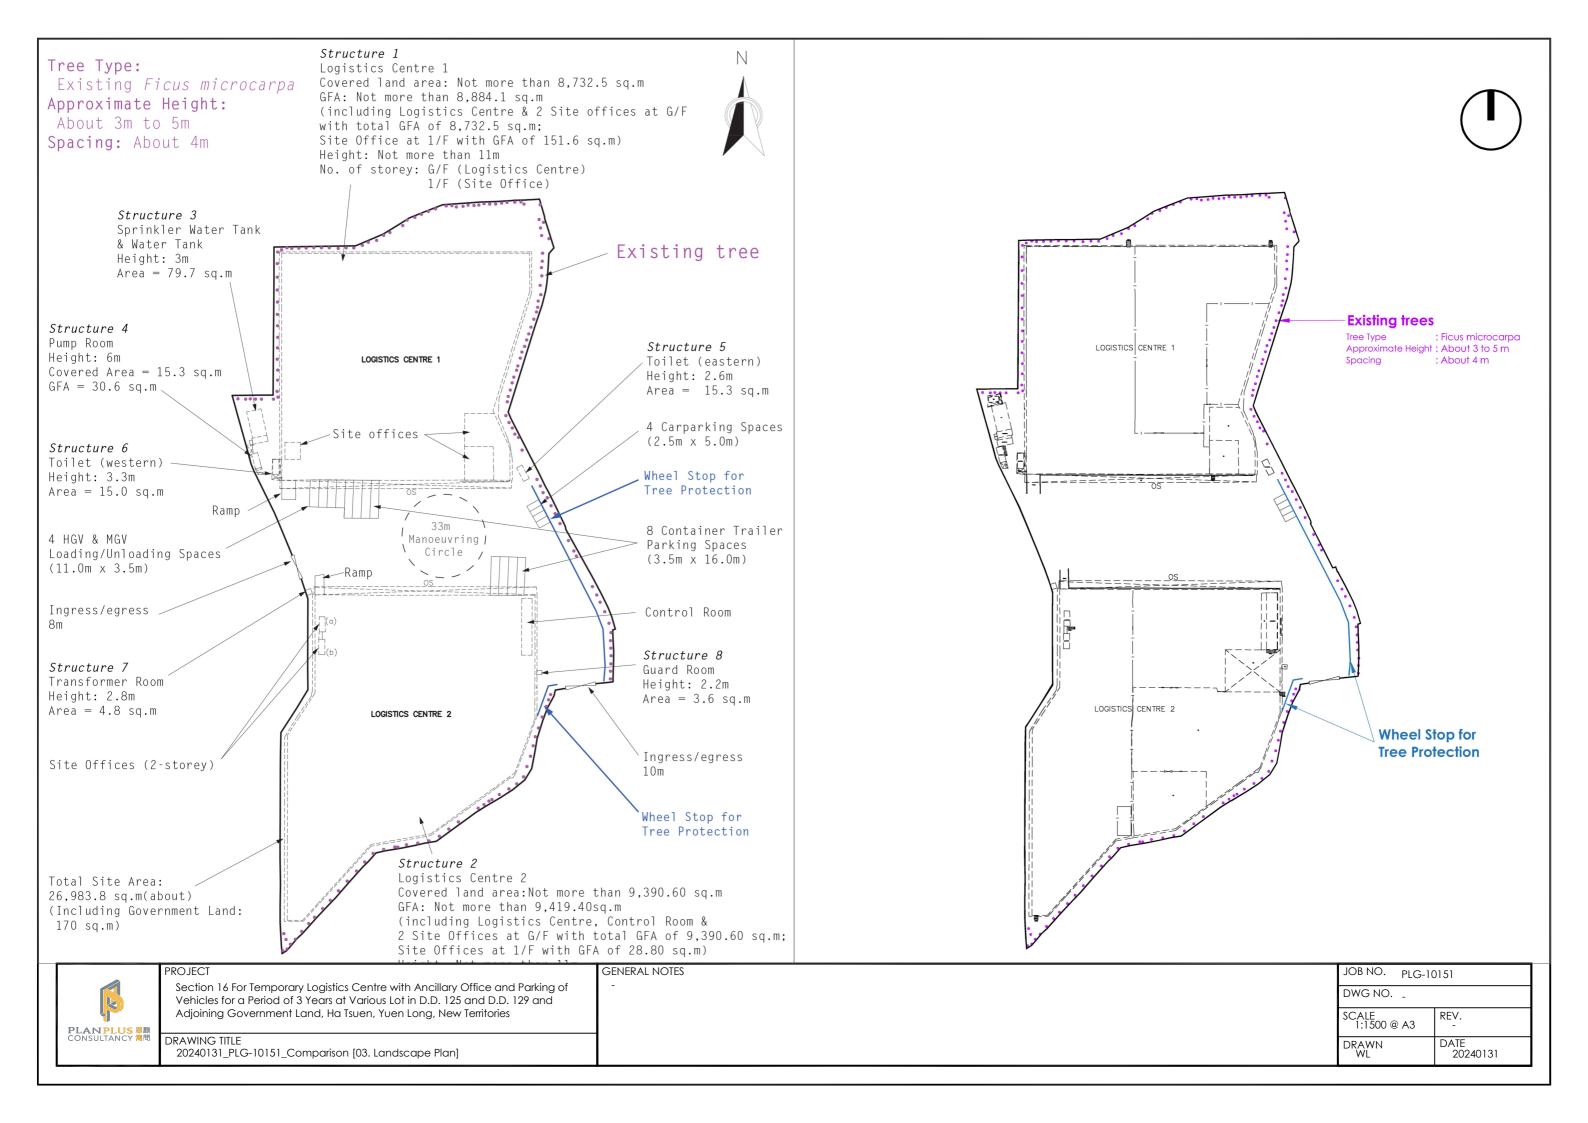

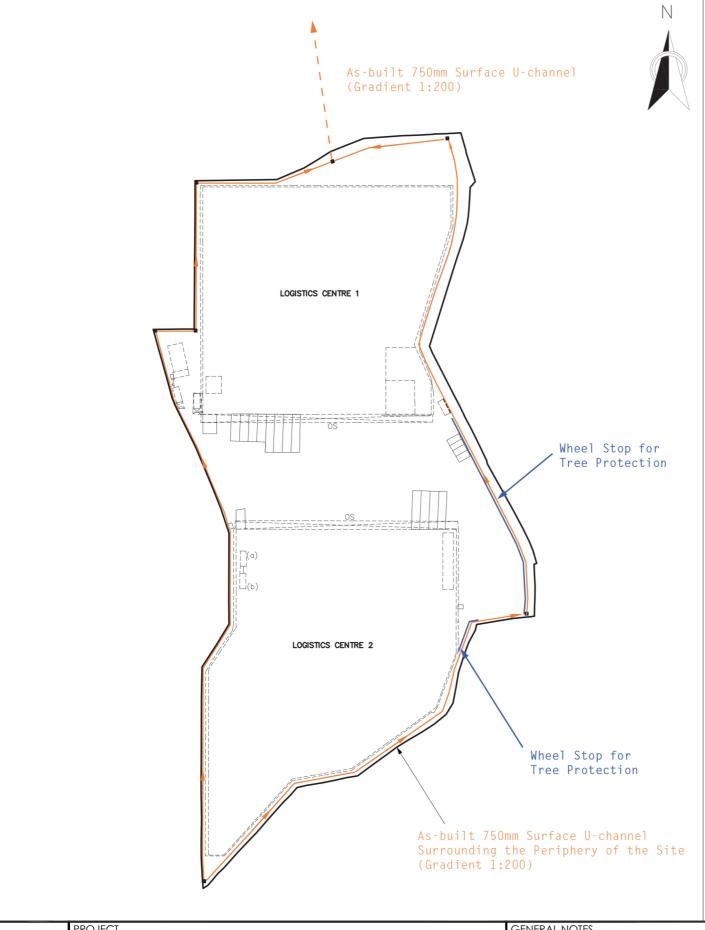

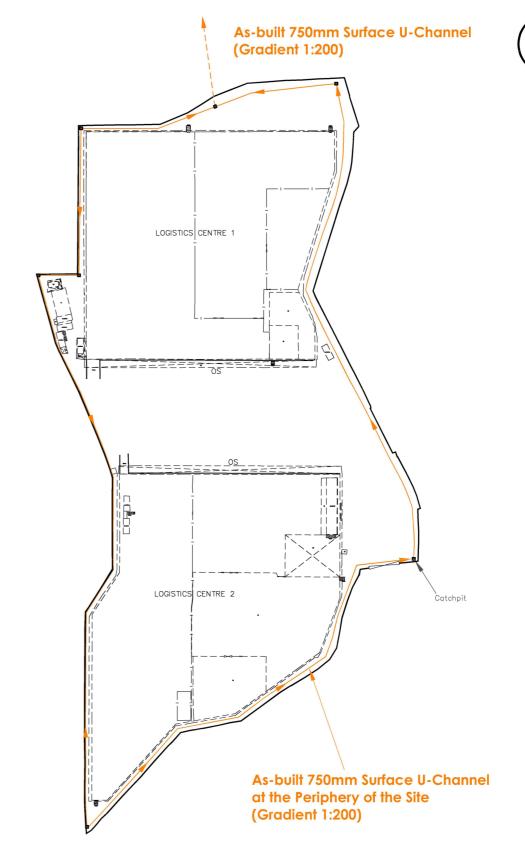



PROJECT

Section 16 For Temporary Logistics Centre with Ancillary Office and Parking of Vehicles for a Period of 3 Years at Various Lot in D.D. 125 and D.D. 129 and Adjoining Government Land, Ha Tsuen, Yuen Long, New Territories

DRAWING TITLE 20240131\_PLG-10151\_Comparison [04.As-built Drainage Plan]


GENERAL NOTES

JOB NO. PLG-10	0151		
DWG NO			
SCALE 1:1500 @ A3	REV.		
DRAWN WL	DATE 20240131		

Ref.: PPC-PLG-10151

### Annex 7

Fire Service Installations Proposal

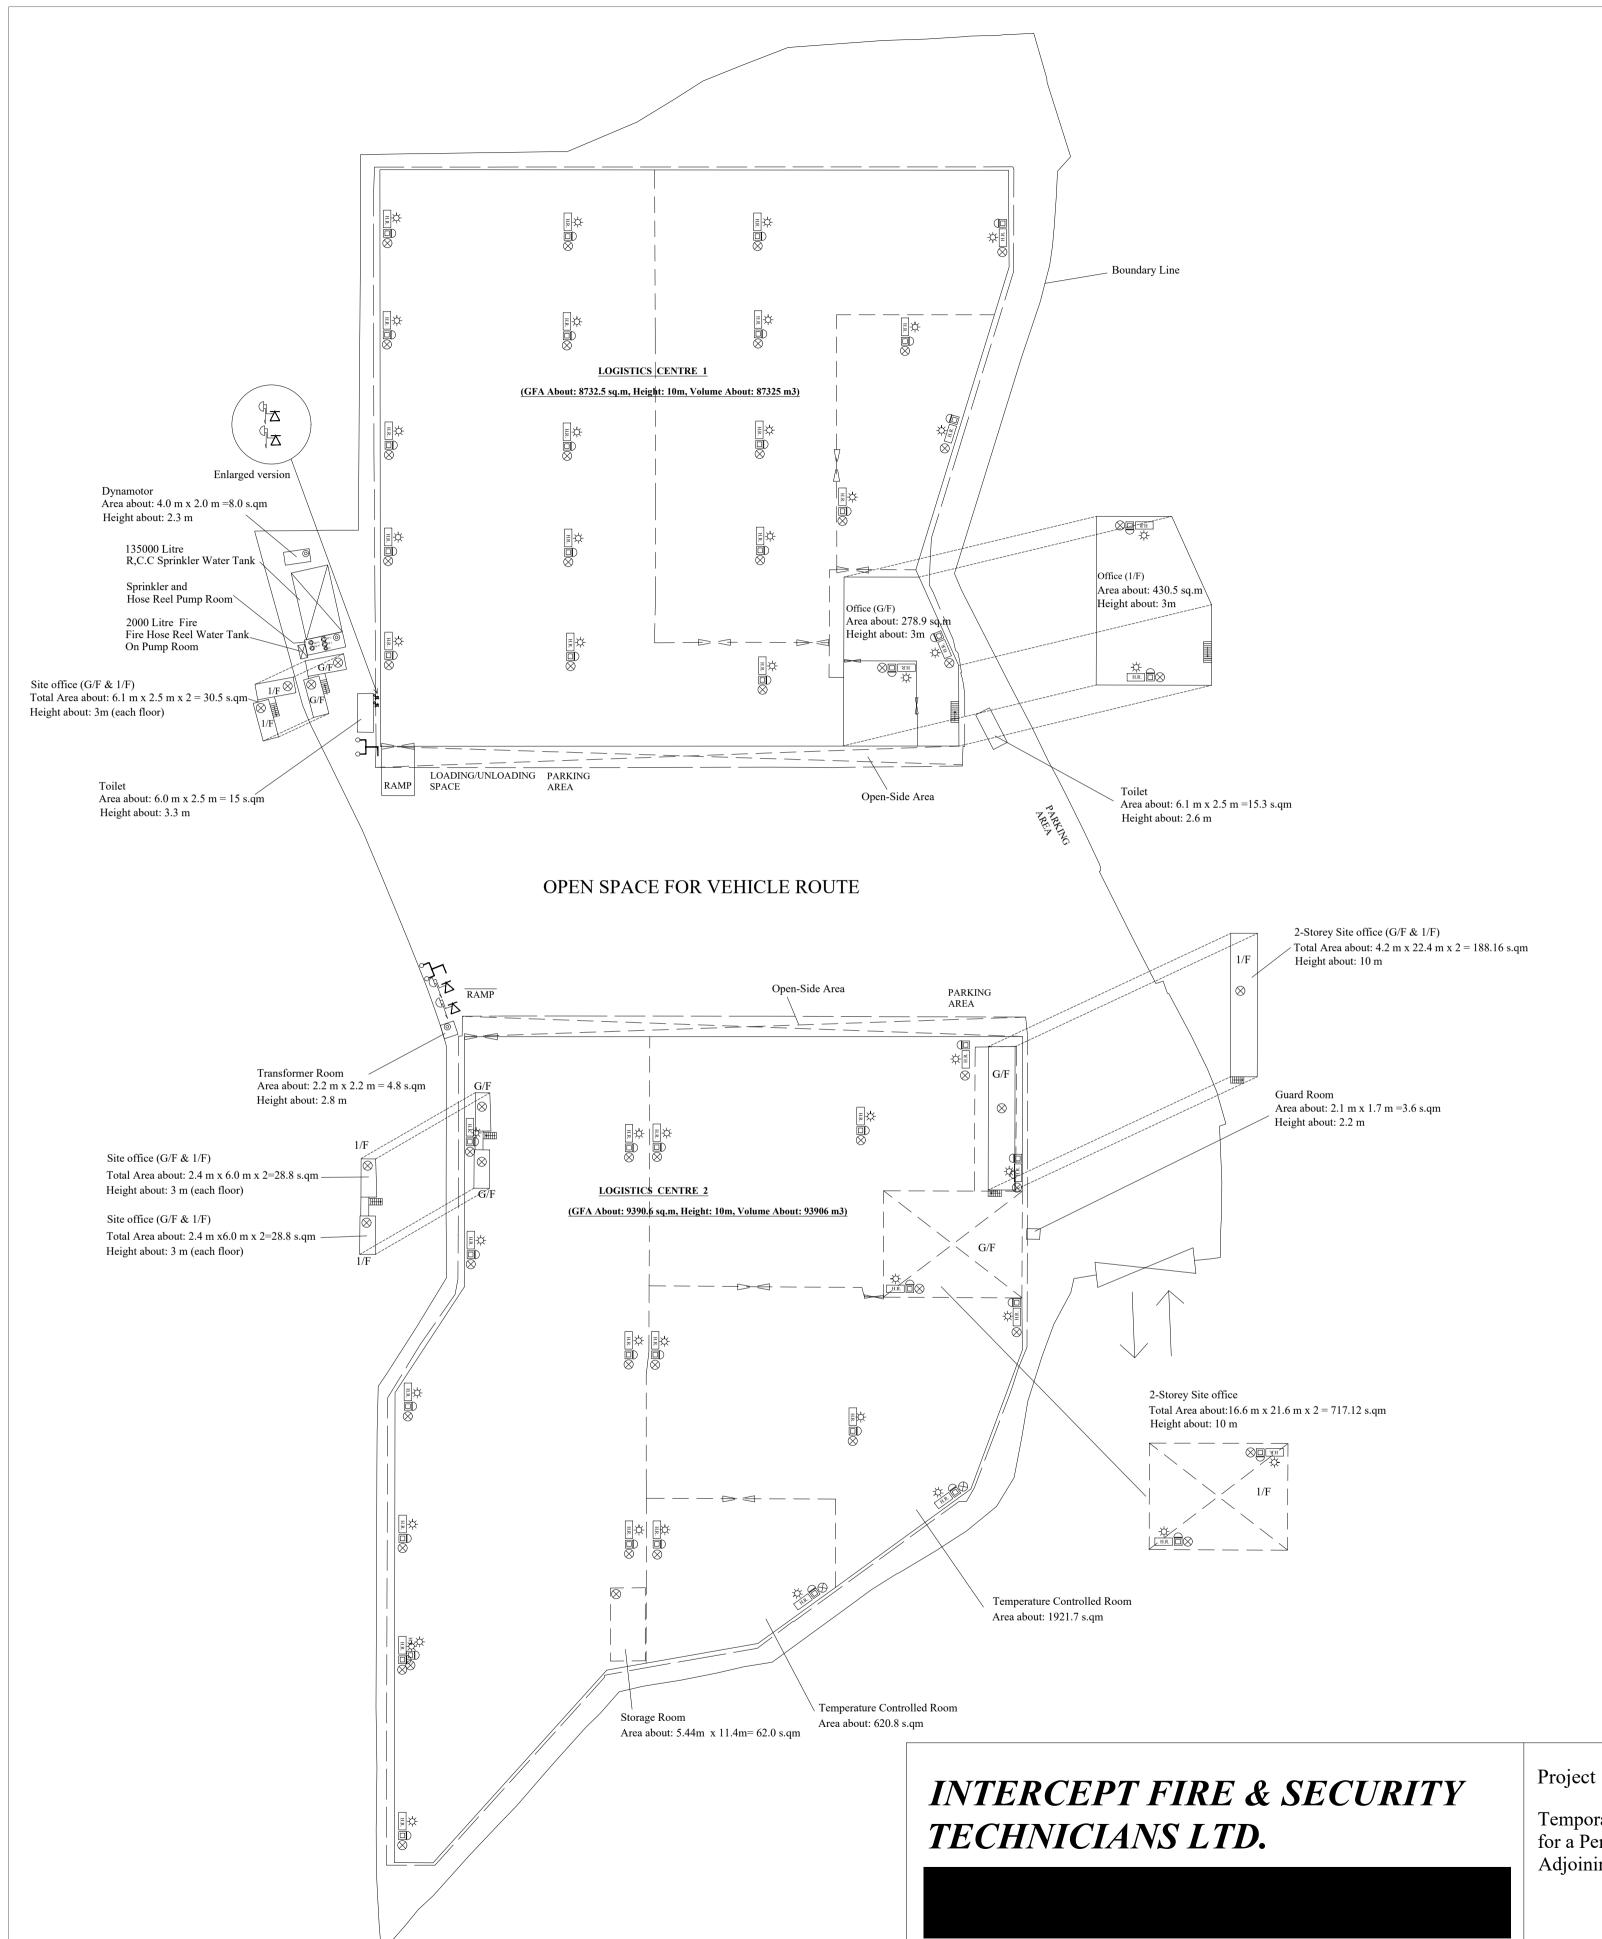

## **F.S.Notes:**

- 1. Sufficient emergency lighting shall be provided througout the entire buildings/structures in accordance with B.S.5266-1:2016 and EN 1838:2013 and FSD Circular Letter No.4/2021
- 2. Sufficient directional and exit sign shall be provided

in accordance with B.S.5266:Part 1 and FSD circular letter 5/2008.

- 3. Sufficient Portable hand-operated Approved appliances shall be provided as required by occupancy and as marked on plans.
- 4. An Automatic sprinkler system supplied by 135,000L sprinkler water tank and hazard class; OH III should be provided to the entire building / structure in accordance with BS EN 12845; 2015 and FSD circular 5/2020. The sprinkler water tank, sprinkler pump room, sprinkler inlet, sprinkler control valve group shall be clearly marked on plans.
- 5. The storage configuration is ST1 & ST2.

ST1: free standing or block stacking with reference to the section 6.3.2

of B.S 12845.and storage pattern is the maximum storage height shall not exceed 4 m & the maximum storage areas shall be 50m2 for any single block.with no less than 2.4m clearance around the block as Ordinary Hazard Group 3 in accordance with LPC BS EN 12845(Storage Category I)


ST2:Post pallets in single rows, with aisles not less than 2.4m wide with reference to be section 6.3.2 of B.S 12845. Maximum storage heights shall not exceed 3.5m & Aisles between rows shall be not less than 2.4m wide as Ordinary Hazard Group 3 in accordance with LPC BS EN 12845(Storage Category:Category I)

- 6. A modified hose reel system supplied by a 2000 litre FS water tank shall be provided There shall be sufficient hose reels to ensure that every part of each building can be reached by a length of not more than 30m of hose reel tubing. The FS water tank, FS pump room and hose reel shall be clearly marked on plans.
- 7. Fire alarm system shall be provided throughout the entire building in accordance with BS 5839 -1: 2017 and FSD Circular Letter no 6/2021. One actuation point and audio warning devices to be located at each hose reel point. This actuation point should include facilities for fire pump start and audio/visual warning device initiation.
- 8. The Sprinkler water Tank & F.S water Tank water supply pipe should be connected to Town Main.
- 9. Source of secondary power supply shall be provided.
- 10. Static or dynamic smoke extraction system is not provided. The openable windows of Logistics Centre "1" & "2" with aggregate area exceeding 6.25% of the floor area as marked on plans (detail see openable window layout plan).
- 11. When A Ventilation/air conditioning control system is provided, It shall stop mechanically induced air movement within a designated compartment.
- 12. Any intended storage or use of dangerous goods as defined in Chapter 295 of the Laws of Hong Kong should be notified to the Director of Fire Services.

# **LEGEND** Gate Valve Non Return Valve Pump Set c/w Motor Sprinkler Control Valve Sprinkler Inlet Fire Hose Reel Set c/w Break Glass and Alarm Bell & Visual Alarm Device Sprinkler Jockey Pump Sprinkler Duty and Standby Pump HR-P1,HR-P2 Hose Reel Duty and Standby Pump 4.0 kg Dry Powder type fire extinguisher 5.0 kg CO2 type fire extinguisher

<b>J</b> ·	Tille:
Temporary Logistics Centre with Ancillary Office and Parking of Vehicle for a Period of 3 Years at Various Lots in D.D.125 and D.D129 and	Proposed
Adjoining Government Land, Ha Tsuen, Yuen Long, New Territories.	Modified
	- Maannea

Title:	Drawn By:	W.C WONG
Proposed Automatic Sprinkler and	Date:	2023-12-18
Modified Hose Reel System	Scale:	1:600 @A1
	Ref. No:	TPB/A/HSK
	<b>Revise Date:</b>	2024-01-15

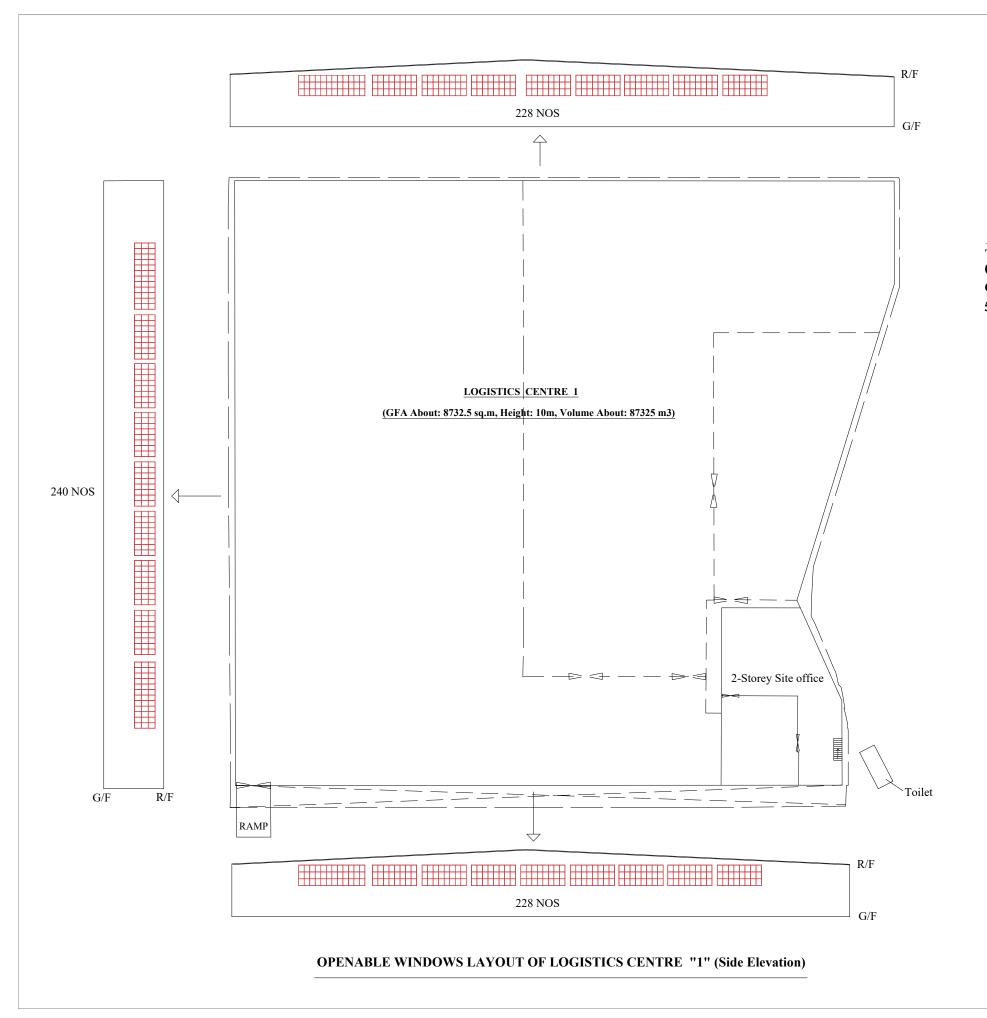

### Legend:

Openable window (Area: 0.8 m x 1 m = 0.8 sq.m)

#### Calculate:

The aggregated area of openable window is: 0.8sq.m x (228 + 228 + 240) nos =556.8 sq.m 6.25% of the floor area is: 8732.5 sq.m x 6.25% = 545.78 sq.m 556.8 sq.m > 545.78 sq.m

# INTERCEPT FIRE & SECURITY TECHNICIANS LTD.




#### Project:

Temporary Logistics Centre with Ancillary Office and Parking of Vehicle for a Period of 3 Years at Various Lots in D.D.125 and D.D129 and Adjoining Government Land, Ha Tsuen, Yuen Long, New Territories.

#### Title:

Proposed Openable window Layout Plan

Drawn By :	W.C WONG		
Date :	2024-01-15		
Scale :	1:600 @A3		
Ref. No:	TPB/A/HSK		
Revise Date:	2024-01-15		

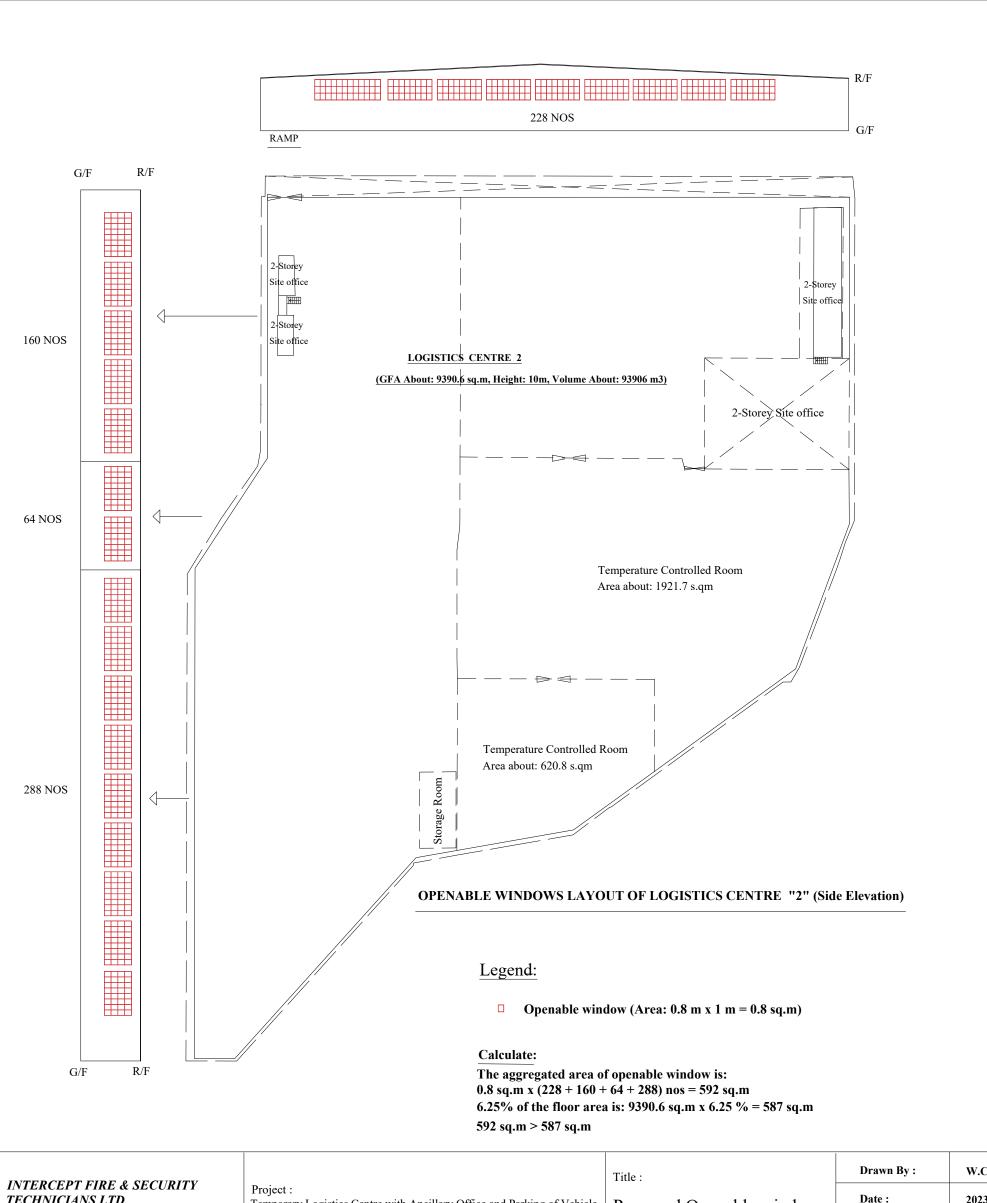

# TECHNICIANS LTD.

Temporary Logistics Centre with Ancillary Office and Parking of Vehicle for a Period of 3 Years at Various Lots in D.D.125 and D.D129 and Adjoining Government Land, Ha Tsuen, Yuen Long, New Territories.

Proposed Openable window	
Lavout Plan	

Drawn By :	W.C WONG
Date :	2023-12-18
Scale :	1:600 @A3
Ref. No:	TPB/A/HSK
Revise Date:	2024-01-15